

REMARKS

2 FT TIE-IN

2 FT TIE-IN

REMARKS

REMARKS

REMARKS

GRAY OR TAN

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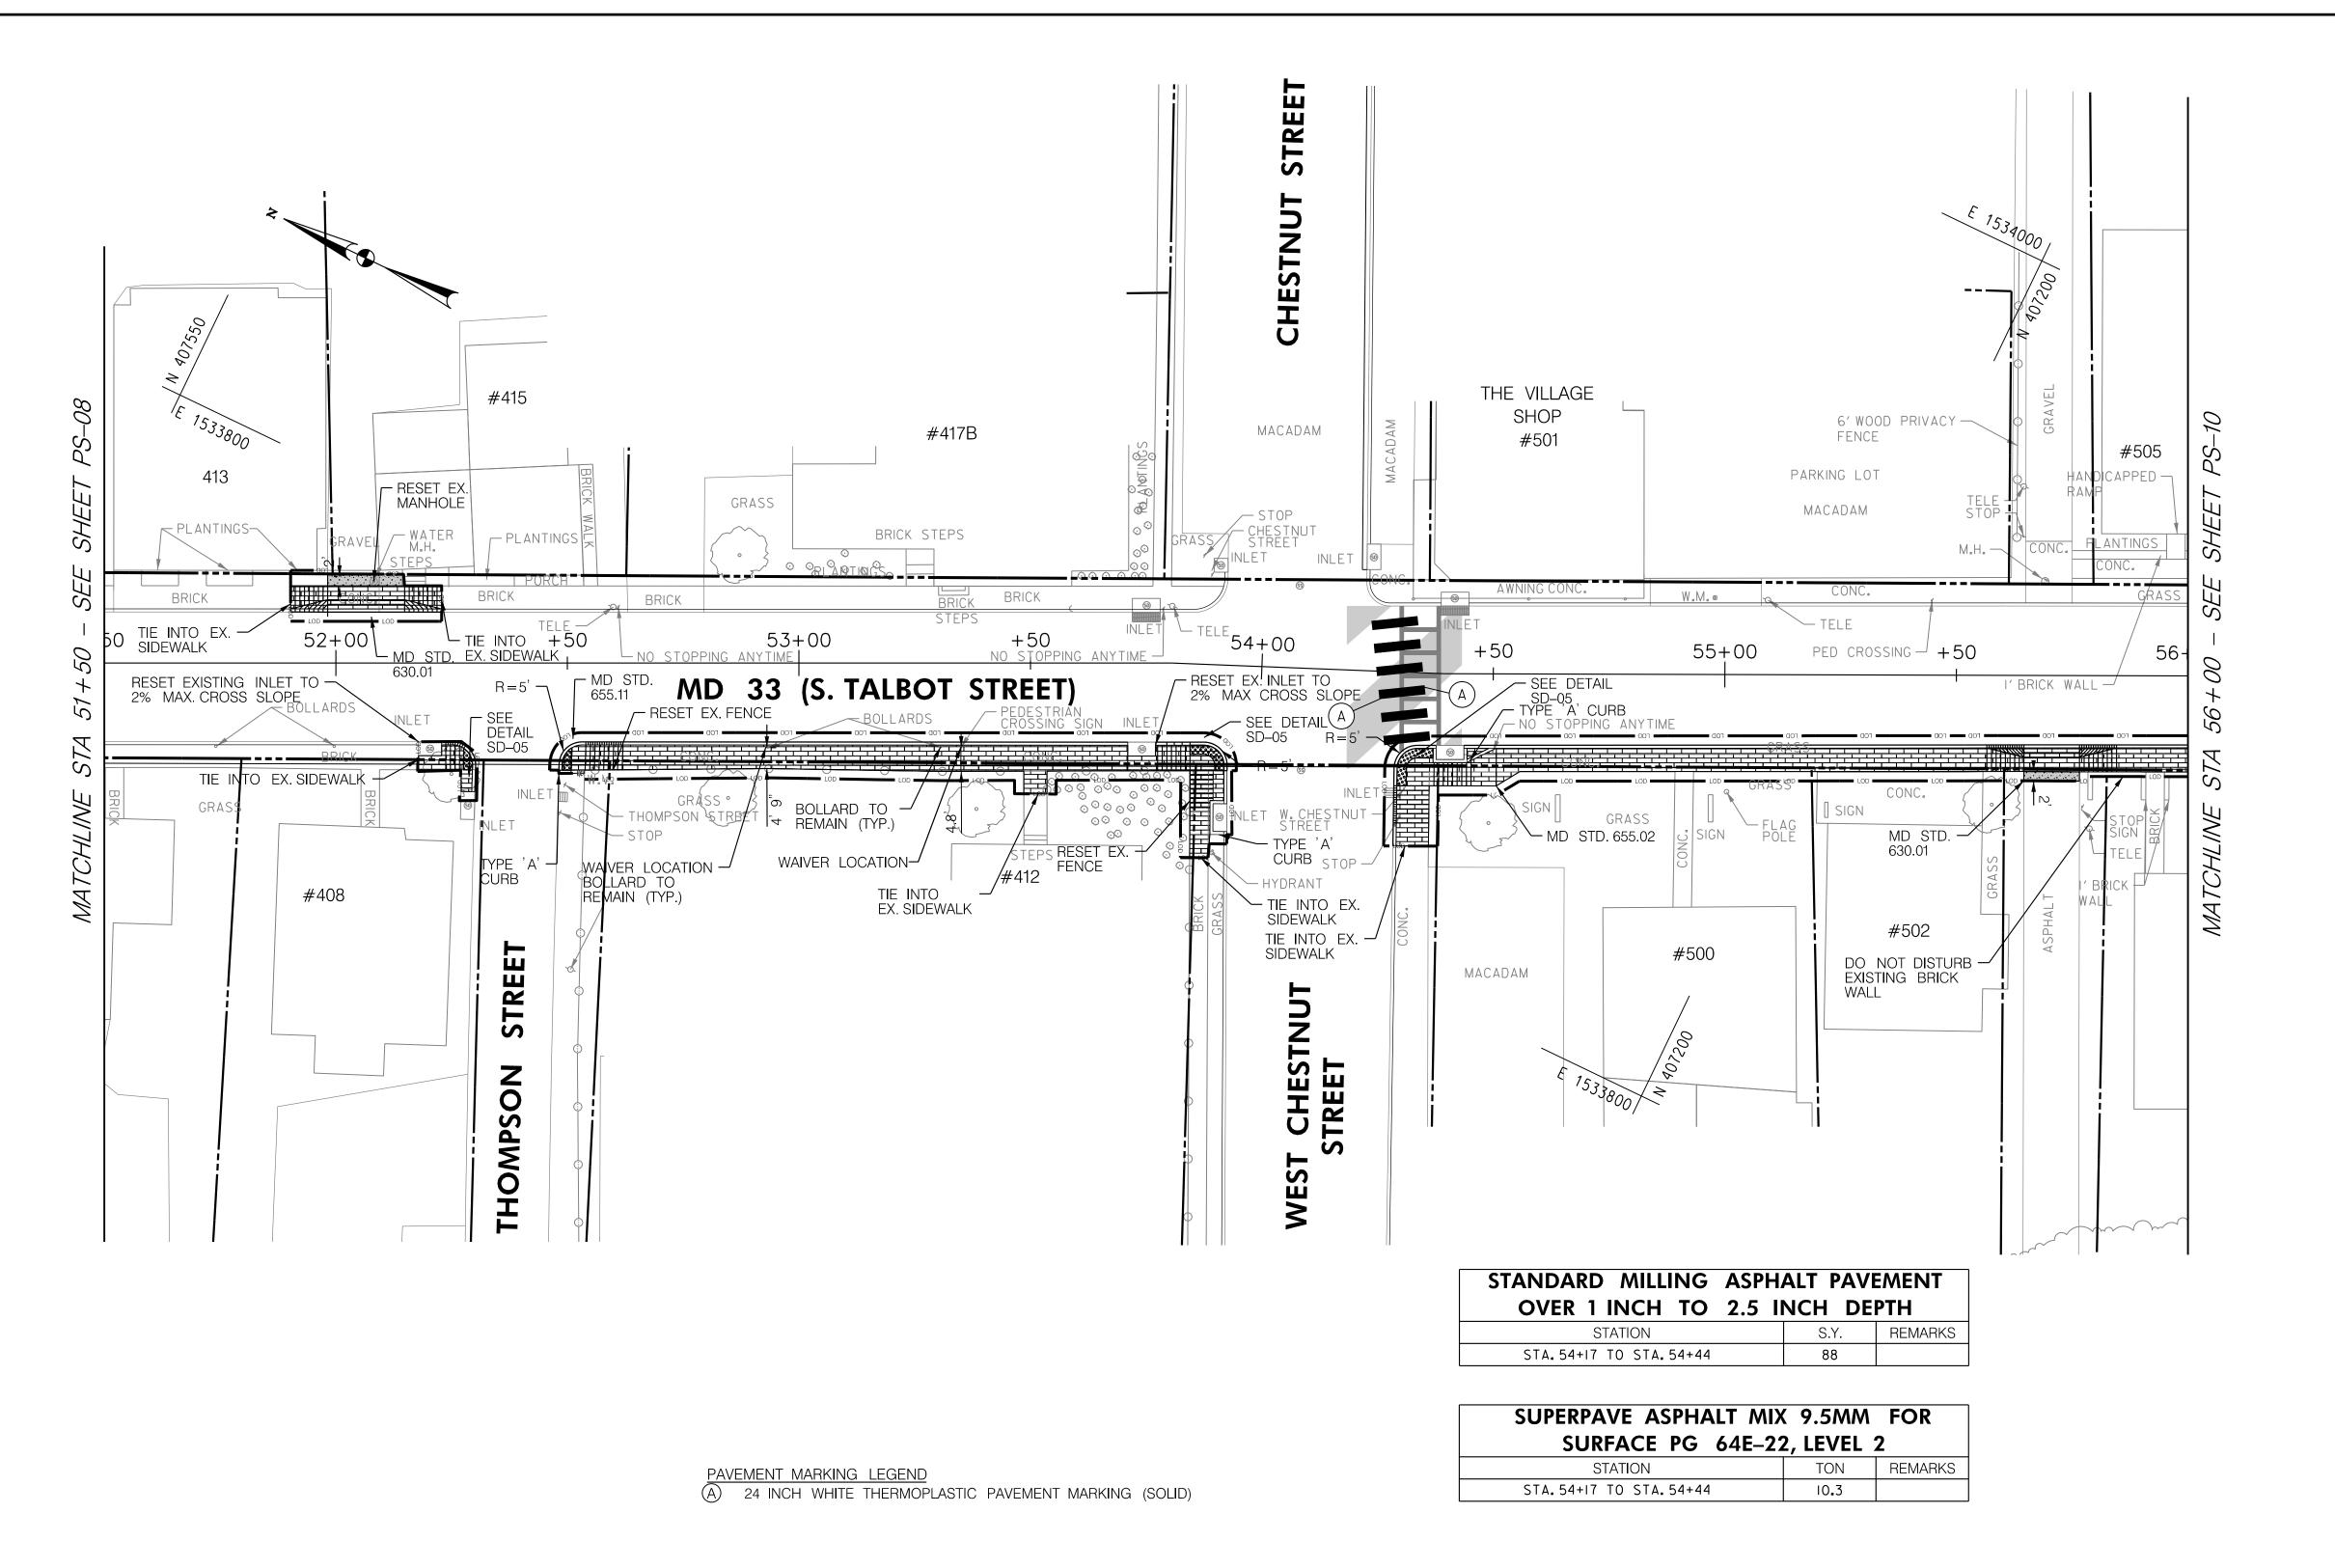
GRAY OR TAN

REMARKS

REMARKS

N/A

PLOTTED: 12/15/2020 FILE: pw:\\shavmpwx.shacadd.ad.mdot.mdstate:SHAEDMS01\Documents\Areawide Projects\AW-ADA Sidewalks Design\Fund 33 Projects\District 2\MTA\Design Submittal No. 8 - MD 33 from Lee St to Spencer Dr\SHA In-house\Roadway\CAD\pHD-P008_MD 33.dgn



10 20 SCALE: I" = 20'

DATUM: NAD 83/91 Horizontal NAVD 88 Vertical

8 INCH PORTLAND CEMENT CONCRETE **PAVEMENT FOR DRIVEWAY MIX 9 STATION REMARKS** 51+98, LT TO 52+15, LT 2 FT TIE-IN 55+65, RT TO 55+77, RT 2 FT TIE-IN

QUANTITY NOTES

GRANITE CURB			
STATION	REMARKS		
52+23, 17' RT TO 52+30, 28' RT	16		
52+48, 23' RT TO 53+71, 17' RT	127		
53+77, 17' RT TO 53+93, 23' RT	20		
54+30, 38' RT TO 54+38, 15' RT	29		
54+44, 15' RT TO 56+00, 15' RT	157		

ADJUST OR REPLACE G	RANITE C	URB
STATION	LF	REMARKS
51+90, 11' LT TO 52+23, 11' LT	33	**

** MATCH EXISTING CURB HEIGHT AT TIE IN POINT

BRICK SIDEWALK		
STATION	SF	REMARKS
51+90, LT TO 52+23, LT	165	
52+18, RT TO 52+29, RT	55	
52+49, RT TO 53+93, RT	885	
54+30, RT TO 56+00, RT	970	

DETECTABLE WARNING SURFACE FOR CURB RAMPS			
STATION SF RE			
52+28, 22' RT	7		
52+49, 23' RT	8		
53+85, 18' RT	19		
54+30, 21' RT	25		

TYPE A CURB ANY HEIGHT OR DEPTH		
STATION	LF	REMARKS
52+48, 24' RT TO 52+54, 24' RT	6	SEE DE-01
53+90, 29' RT TO 53+94, 37' RT	21	
54+38, 16' RT TO 54+44, 19' RT	14	
54+44, 19' RT TO 54+51, 16' RT	7	

PLACING FURNISHED TOPSOIL 4 INCH DEPTH		
52+18, RT TO 52+27, RT	4	
52+54, RT TO 53+49, RT	22	
53+54, RT TO 53+86, RT	12	
54+37, RT TO 54+89, RT	15	
54+93, RT TO 55+20 ,RT	6	
55+56, RT TO 55+65, RT	2	

TURFGRASS SOD ESTABLISHMENT			
STATION	SY	REMARKS	
52+18, RT TO 52+27, RT	4		
52+54, RT TO 53+49, RT	22		
53+54, RT TO 53+86, RT	12		
54+37, RT TO 54+89, RT	15		
54+93, RT TO 55+20 ,RT	6		
55+56, RT TO 55+65, RT	2		

NOTE: SAME-DAY STABILIZATION SHALL BE PROVIDED FOR ALL DISTURBED AREAS.

MARYLAND DEPARTMENT OF TRANSPORTATION STATE HIGHWAY **ADMINISTRATION**

INNOVATIVE CONTRACTING DIVISION

REPACEMENT AND REPAIR OF SIDEWALKS IN DISTRICT 2 AREA WIDE

MD 33 (TALBOT STREET) 200' NORTH OF LEE STREET TO

SHEET NO. 20 OF 26

150' SOUTH OF SPENCER DRIVE


ROADWAY PLAN SHEET


DATE MARCH 2020 CONTRACT NO. TA2295133 TALBOT COUNTY COUNTY ___ PNK LOGMILE _ 12.852 TO 13.983 HORIZONTAL SCALE _____N/A VERTICAL SCALE ____

PS-09 OF PS-14

THIS SHEET IS LOCATED ENTIRELY WITHIN THE CHESAPEAKE BAY CRITICAL AREA NOTE TO CONTRACTOR:

- 1. ALL DISTURBED AREAS SHALL BE TEMPORARILY STABILIZED AT THE END OF EACH WORK DAY WITH TYPE 'E' SOIL STABILIZATION MATTING IN PERVIOUS AREAS OR GRADED AGGREGATE BASE COURSE IN IMPERVIOUS AREAS.
- 2. NO DISTURBED AREA SHALL BE LEFT UNSTABILIZED OVERNIGHT UNLESS THE RUNOFF IS DIRECTED TO AN MDE APPROVED SEDIMENT CONTROL DEVICE.
- 3. SEE GENERAL NOTES ON SHEET DE-01 FOR ADDITIONAL CONSTRUCTION NOTES FOR CURB RAMPS, SIDEWALKS, AND MEDIANS.
- 4. ALL TRANSITION SIDEWALK PANELS MUST BE CONSTRUCTED 5' MINIMUM OR TO THE NEXT EXISTING JOINT OR AS DIRECTED BY THE ENGINEER.
- 5. DRIVEWAY TIE-INS SHOULD MATCH EXISTING MATERIAL (ASPHALT/GRAVEL/BRICK)

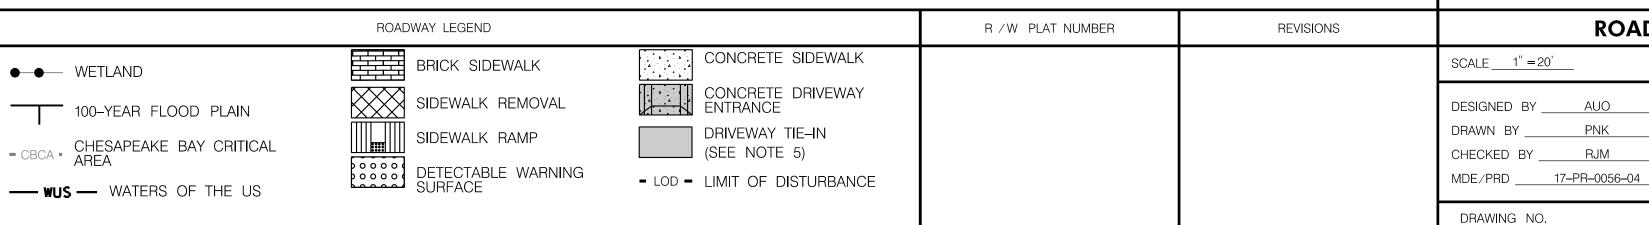

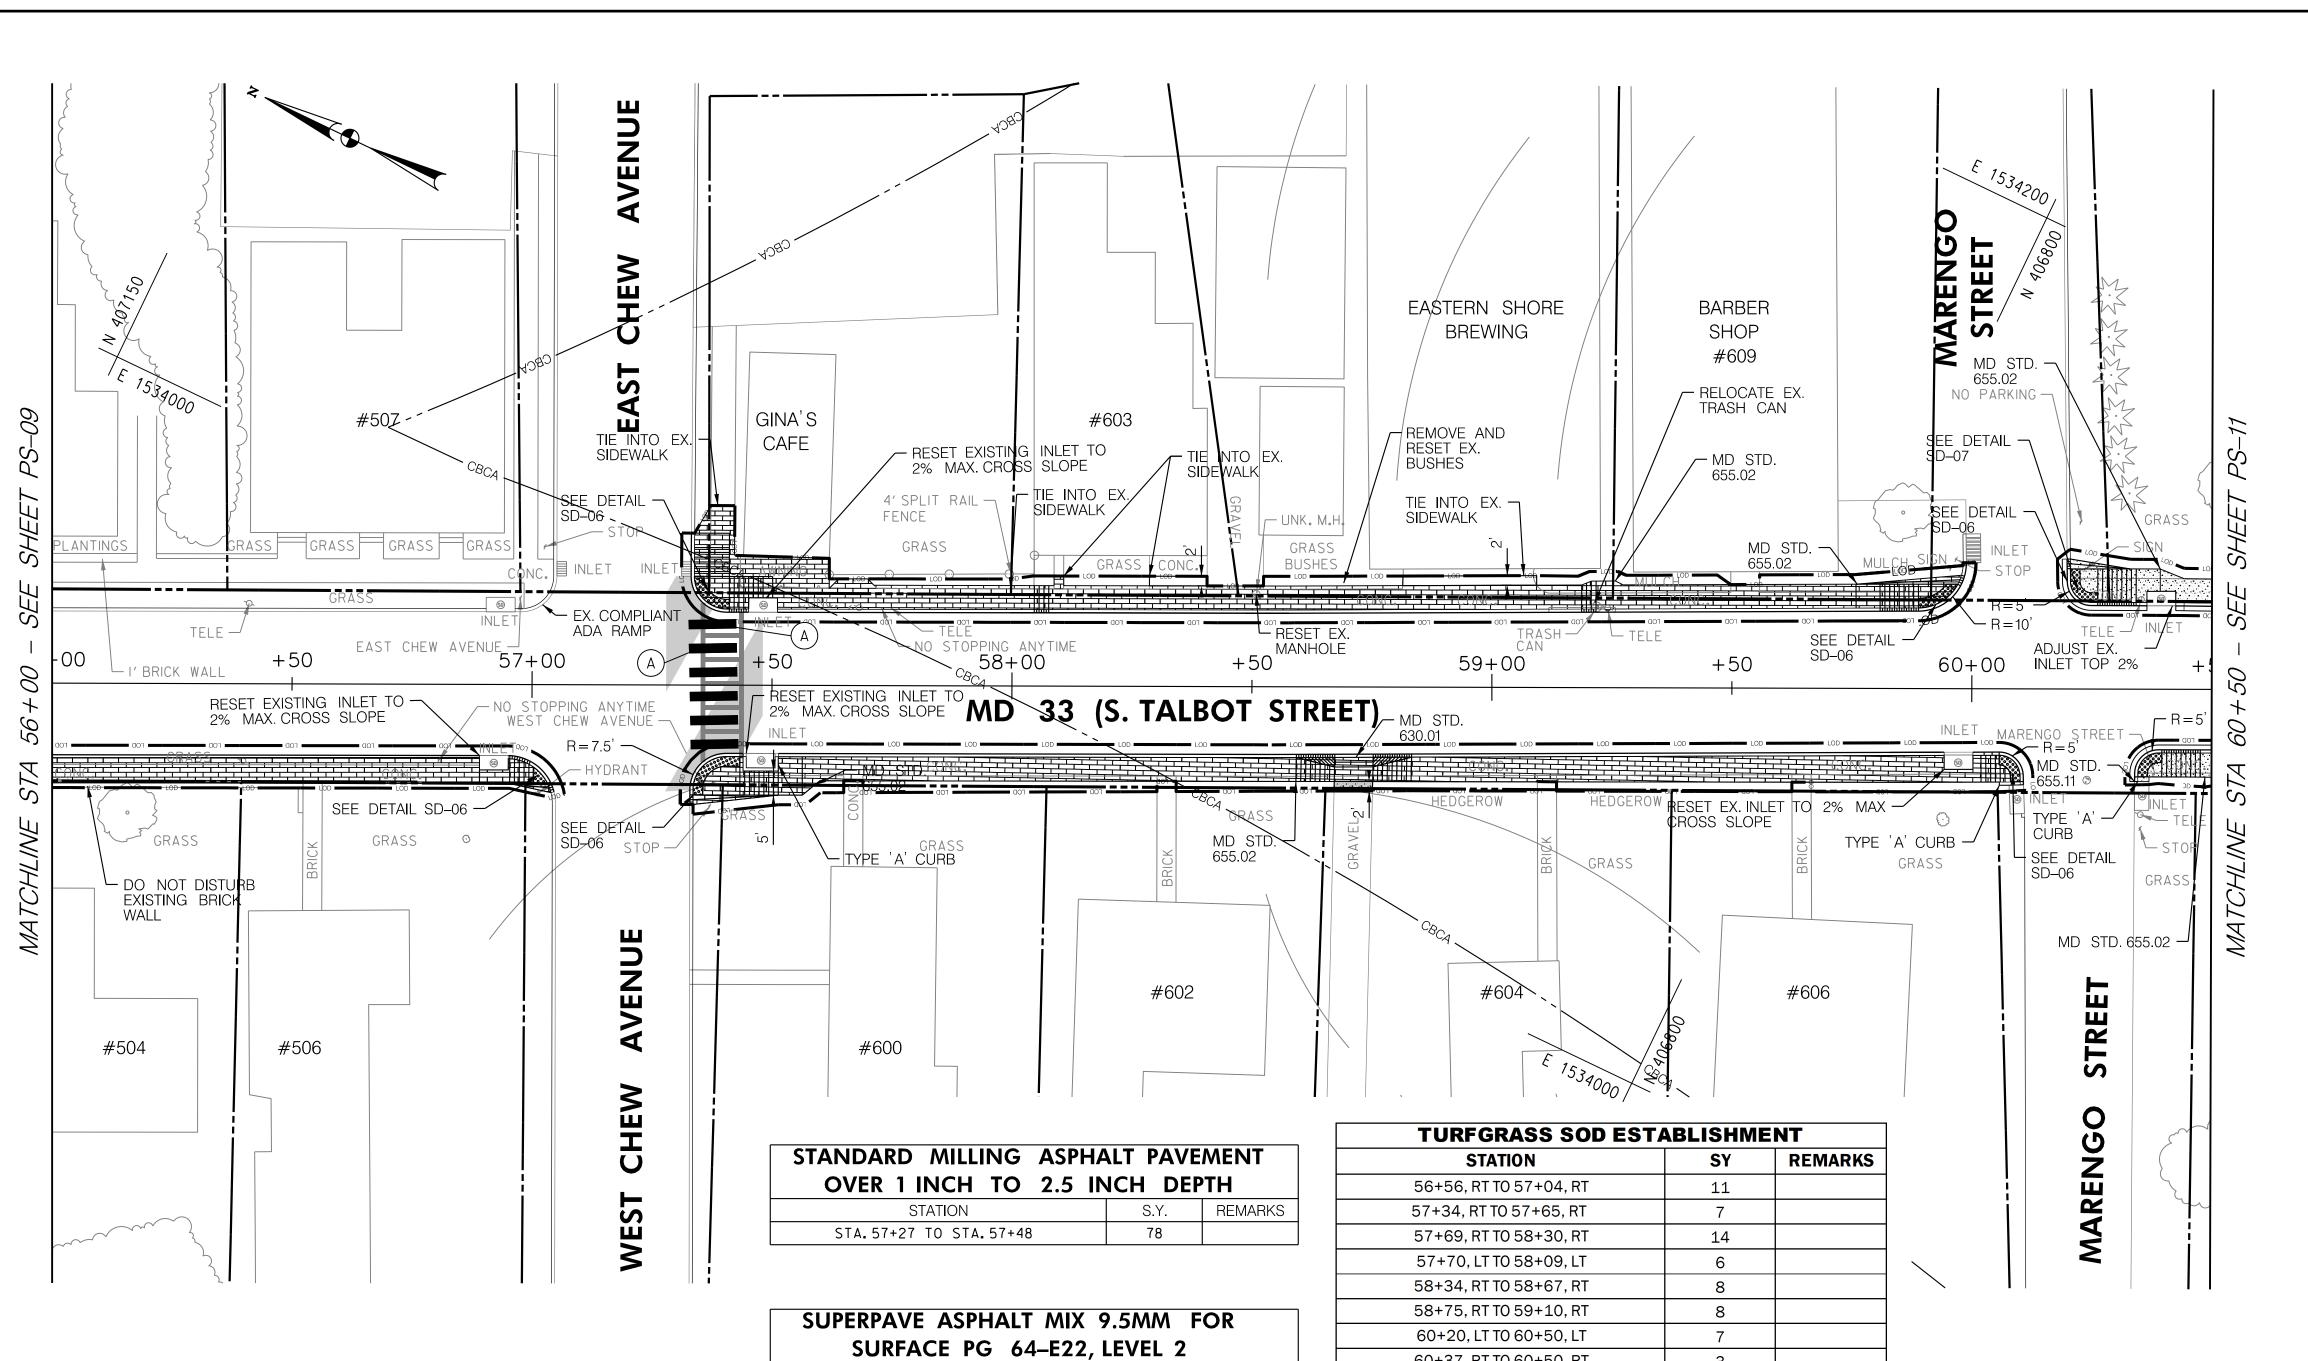

STATION REMARKS TON

9.2

60+37, RT TO 60+50, RT 3 **BRICK SIDEWALK REMARKS STATION** 56+00, RT TO 57+04, RT 525 57+34, RT TO 60+11, RT 1435

57+34, LT TO 59+98, LT

PAVEMENT MARKING LEGEND (A) 24 INCH WHITE THERMOPLASTIC PAVEMENT MARKING (SOLID)

STA. 57+27 TO STA. 57+48

QUANTITY NOTES

8 INCH PORTLAND CEMENT CONCRETE PAVEMENT FOR DRIVEWAY MIX 9			
	STATION	SY	REMARK
	58+59, RT TO 58+83, RT	2	2 FT TIE-IN

TYPE A CURB ANY HEIGHT OR DEPTH		
STATION	LF	REMARKS
57+44, 15' RT TO 57+51, 18' RT	14	
60+06, 20' RT TO 60+11, 20' RT	6	SEE DE-01
60+34, 19' RT TO 60+37, 19' RT	5	SEE DE-01

GRANITE CURB

STATION	LF	REMARKS
56+00, 15' RT TO 56+89, 15' RT	89	
56+95, 15' RT TO 57+05, 22' RT	13	
57+33, 25' RT TO 57+44, 14' RT	19	
57+34, 32' LT TO 57+45, 16' LT	25	
57+51, 15' LT TO 59+99, 26' LT	272	
57+51, 14' RT TO 59+94, 13' RT	243	
60+00, 13' RT TO 69+11, 19' RT	16	

TYPE A COMBINATION CURB AND GUTTER **ANY HEIGHT OR DEPTH**

ANT HEIGHT ON BETTIN		
STATION	LF	REMARKS
60+20, 27' LT TO 60+36, 17' LT	25	
60+34, 19' RT TO 60+50, 13' RT	21	
60+42, 17' LT TO 60+50, 17' LT	8	

5 INCH CONCRETE SIDEWALK		
STATION	SF	REMARKS
60+20, LT TO 60+50, LT	165	
60+34, RT TO 60+50, RT	65	

DETECTABLE WARNING SURFACE FOR CURB RAMPS STATION REMARKS 57+00, 17' RT 57+34, 23' LT 20 57+34, 22' RT 27 59+89, 19' LT 17 60+06, 14' RT 13 60+20, 25' LT 19

60+35, 18' RT

PLACING FURNISHED TOPSOIL 4 INCH DEPTH			
STATION	SY	REMARKS	
56+56, RT TO 57+04, RT	11		
57+34, RT TO 57+65, RT	7		
57+69, RT TO 58+30, RT	14		
57+70, LT TO 58+09, LT	6		
58+34, RT TO 58+67, RT	8		
58+75, RT TO 59+10, RT	8		
60+20, LT TO 60+50, LT	7		
60+37, RT TO 60+50, RT	3		

NOTE: SAME-DAY STABILIZATION SHALL BE PROVIDED FOR ALL DISTURBED AREAS.

MARYLAND DEPARTMENT OF TRANSPORTATION

INNOVATIVE CONTRACTING DIVISION

REPACEMENT AND REPAIR OF SIDEWALKS IN DISTRICT 2 AREA WIDE

OF LEE STREET TO

MD 33 (TALBOT STREET) 200' NORTH STATE HIGHWAY **ADMINISTRATION**

150' SOUTH OF SPENCER DRIVE

ROADWAY PLAN SHEET

DATE MARCH 2020 CONTRACT NO. ____TA2295133 TALBOT COUNTY COUNTY ____ PNK LOGMILE __ 12.852 TO 13.983 HORIZONTAL SCALE _____N/A

VERTICAL SCALE _____ PS-10 OF PS-14 SHEET NO. 21 OF 26 DRAWING NO.

10 20 SCALE: I" = 20'

DATUM: NAD 83/91 Horizontal NAVD 88 Vertical

NOTE TO CONTRACTOR:


THE CHESAPEAKE BAY CRITICAL AREA

THIS SHEET IS PARTIALLY LOCATED ENTIRELY WITHIN

- 1. ALL DISTURBED AREAS SHALL BE TEMPORARILY STABILIZED AT THE END OF EACH WORK DAY WITH TYPE 'E' SOIL STABILIZATION MATTING IN PERVIOUS AREAS OR GRADED AGGREGATE BASE COURSE IN IMPERVIOUS AREAS.
- 2. NO DISTURBED AREA SHALL BE LEFT UNSTABILIZED OVERNIGHT UNLESS THE RUNOFF IS DIRECTED TO AN MDE APPROVED SEDIMENT CONTROL DEVICE.
- 3. SEE GENERAL NOTES ON SHEET DE-01 FOR ADDITIONAL CONSTRUCTION NOTES FOR CURB RAMPS, SIDEWALKS, AND MEDIANS.
- 4. ALL TRANSITION SIDEWALK PANELS MUST BE CONSTRUCTED 5' MINIMUM OR TO THE NEXT EXISTING JOINT OR AS DIRECTED BY THE ENGINEER.
- 5. DRIVEWAY TIE-INS SHOULD MATCH EXISTING MATERIAL (ASPHALT/GRAVEL/BRICK)

ROADWAY LEGEND R / W PLAT NUMBER REVISIONS CONCRETE SIDEWALK $SCALE _{\underline{}} 1" = 20'$ BRICK SIDEWALK ● WETLAND CONCRETE DRIVEWAY ENTRANCE SIDEWALK REMOVAL 100-YEAR FLOOD PLAIN DESIGNED BY ____AUO DRIVEWAY TIE-IN SIDEWALK RAMP - CBCA - CHESAPEAKE BAY CRITICAL AREA (SEE NOTE 5) CHECKED BY _____RJM DETECTABLE WARNING SURFACE MDE/PRD <u>17-PR-0056-04</u> - LOD - LIMIT OF DISTURBANCE

1565

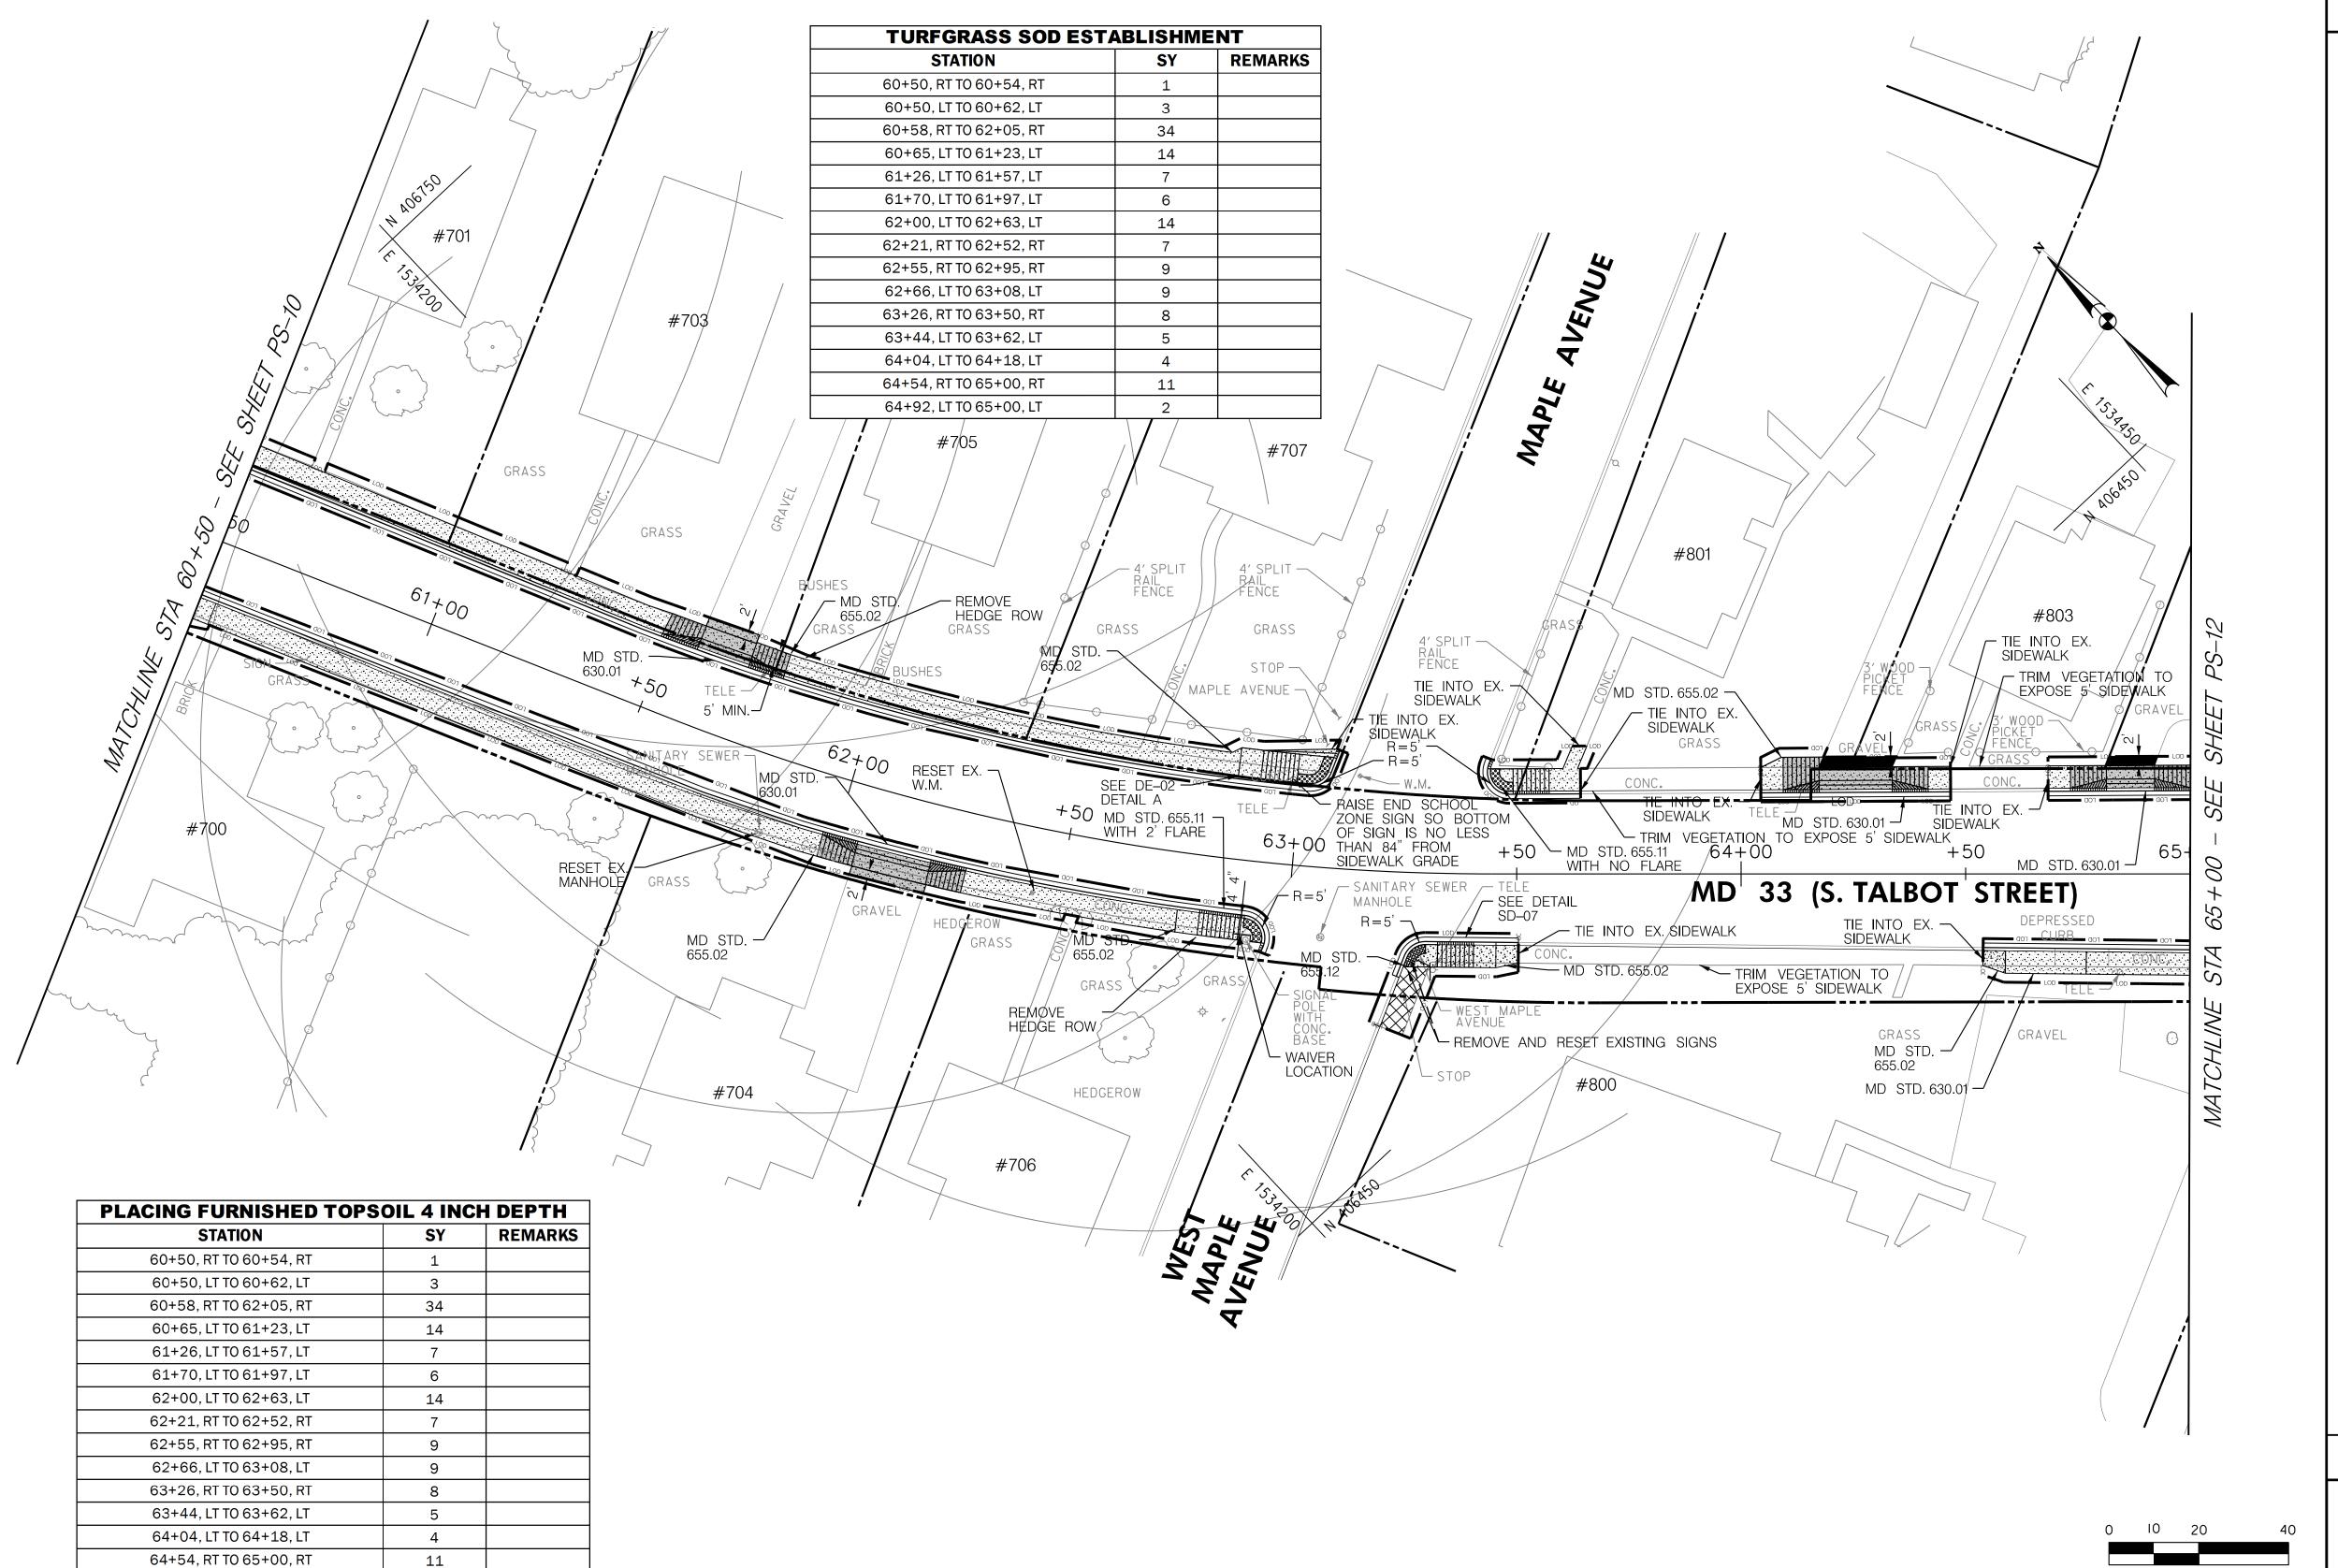

SCALE: I" = 20'

R / W PLAT NUMBER

DATUM: NAD 83/91 Horizontal NAVD 88 Vertical

REVISIONS

8 INCH PORTLAND CEMENT CONCRETE **PAVEMENT FOR DRIVEWAY MIX 9** REMARKS **STATION** 61+49, LT TO 61+78, LT 16 61+57, LT TO 61+69, LT 2 FT TIE-IN 3 61+97, RT TO 62+29, RT 19 62+05, RT TO 62+22, RT 2 FT TIE-IN 4 64+09, LT TO 64+62, LT 21 64+17, LT TO 64+35, LT 2 FT TIE-IN 5 64+73, LT TO 65+00, LT 15

64+81, LT TO 64+92, LT

QUANTITY NOTES

TYPE A COMBINATION CUI		GUTTER
ANY HEIGHT AND STATION	DEPIH	REMARKS
60+50, I3' RT TO 62+95, 20' RT	253	,
60+50, 17'LT TO 63+09, 26'LT	259	
63+23, 23'RT TO 63+50, I5'RT	32	
63+44, 26' LT TO 63+64, 18' LT	27	
64+04, 18'LT TO 64+47, 18'LT	43	
64+54, I6'RT TO 65+00, I7'RT	47	
64+68, I8'LT TO 65+00, I8'LT	32	

2 FT TIE-IN

3

5 INCH CONCRET	E SIDEWAL	.K
STATION	S.F.	REMARKS
60+50, RT TO 61+97, RT	745	
60+50, LT TO 61+49, LT	480	
61+78, LT TO 63+08, LT	640	
62+29, RT TO 62+93, RT	320	
63+25, RT TO 63+50, RT	120	
63+46, LT TO 63+64, LT	100	
64+04, LT TO 64+09, LT	35	
64+42, LT TO 64+47, LT	25	
64+54, RT TO 65+00, RT	230	
64+68, LT TO 64+73, LT	25	

DETECTABLE WARNING SURFACE FOR CURB RAMPS			
STATION	SF	REMARKS	
62+91, 15' RT	12		
62+99, 18' LT	20		
63+25, 22' RT	21		
63+44, 23' LT	14		

CLASS 2 EXCAVATION			
STATION	C.Y.	REMARKS	
63+21, RT TO 63+31, RT	2		

NOTE: SAME-DAY STABILIZATION SHALL BE PROVIDED FOR ALL DISTURBED AREAS.

INNOVATIVE CONTRACTING DIVISION REPACEMENT AND REPAIR OF SIDEWALKS IN DISTRICT 2 AREA WIDE MARYLAND DEPARTMENT

OF TRANSPORTATION STATE HIGHWAY **ADMINISTRATION**

MD 33 (TALBOT STREET) 200' NORTH OF LEE STREET TO

150' SOUTH OF SPENCER DRIVE **ROADWAY PLAN SHEET**

SCALE 1" = 20'	_	DATE MAR	CH 2020 CONTRA	ACT NO	TA2295133
DESIGNED BY	AUO		COUNTY	TALBOT C	OUNTY
DRAWN BY	PNK		LOGMILE	12.852 TO	13.983
CHECKED BY	RJM		HORIZONTAL SC	CALE	N/A

MDE/PRD <u>17-PR-0056-04</u> VERTICAL SCALE ____ DRAWING NO. PS-11 OF PS-14 SHEET NO. 22 OF 26

● WETLAND

SIDEWALK REMOVAL SIDEWALK RAMP

ROADWAY LEGEND

CONCRETE DRIVEWAY ENTRANCE DRIVEWAY TIE-IN ☐ (SEE NOTE 5) - LOD - LIMIT OF DISTURBANCE

CONCRETE SIDEWALK BRICK SIDEWALK

- 100-YEAR FLOOD PLAIN DETECTABLE WARNING SURFACE

- CBCA - CHESAPEAKE BAY CRITICAL AREA --- WUS --- WATERS OF THE US

FILE: pw:\\shavmpwx.shacadd.ad.mdot.mdstate:SHAEDMS01\Documents\Areawide Projects\AW-ADA Sidewalks Design\Fund 33 Projects\District 2\MTA\Design Submittal No. 8 - MD 33 from Lee St to Spencer Dr\SHA In-house\Roadway\CAD\pHD-P011_MD 33.dgn

2

1. ALL DISTURBED AREAS SHALL BE TEMPORARILY STABILIZED AT THE END OF EACH WORK DAY WITH TYPE 'E' SOIL

STABILIZATION MATTING IN PERVIOUS AREAS OR GRADED AGGREGATE BASE COURSE IN IMPERVIOUS AREAS.

NOTE TO CONTRACTOR:


2. NO DISTURBED AREA SHALL BE LEFT UNSTABILIZED OVERNIGHT UNLESS THE RUNOFF IS DIRECTED TO AN MDE APPROVED SEDIMENT CONTROL DEVICE.

5. DRIVEWAY TIE-INS SHOULD MATCH EXISTING MATERIAL (ASPHALT/GRAVEL/BRICK)

64+92, LT TO 65+00, LT

3. SEE GENERAL NOTES ON SHEET DE-01 FOR ADDITIONAL CONSTRUCTION NOTES FOR CURB RAMPS, SIDEWALKS, AND MEDIANS.

4. ALL TRANSITION SIDEWALK PANELS MUST BE CONSTRUCTED 5' MINIMUM OR TO THE NEXT EXISTING JOINT OR AS DIRECTED BY THE ENGINEER.

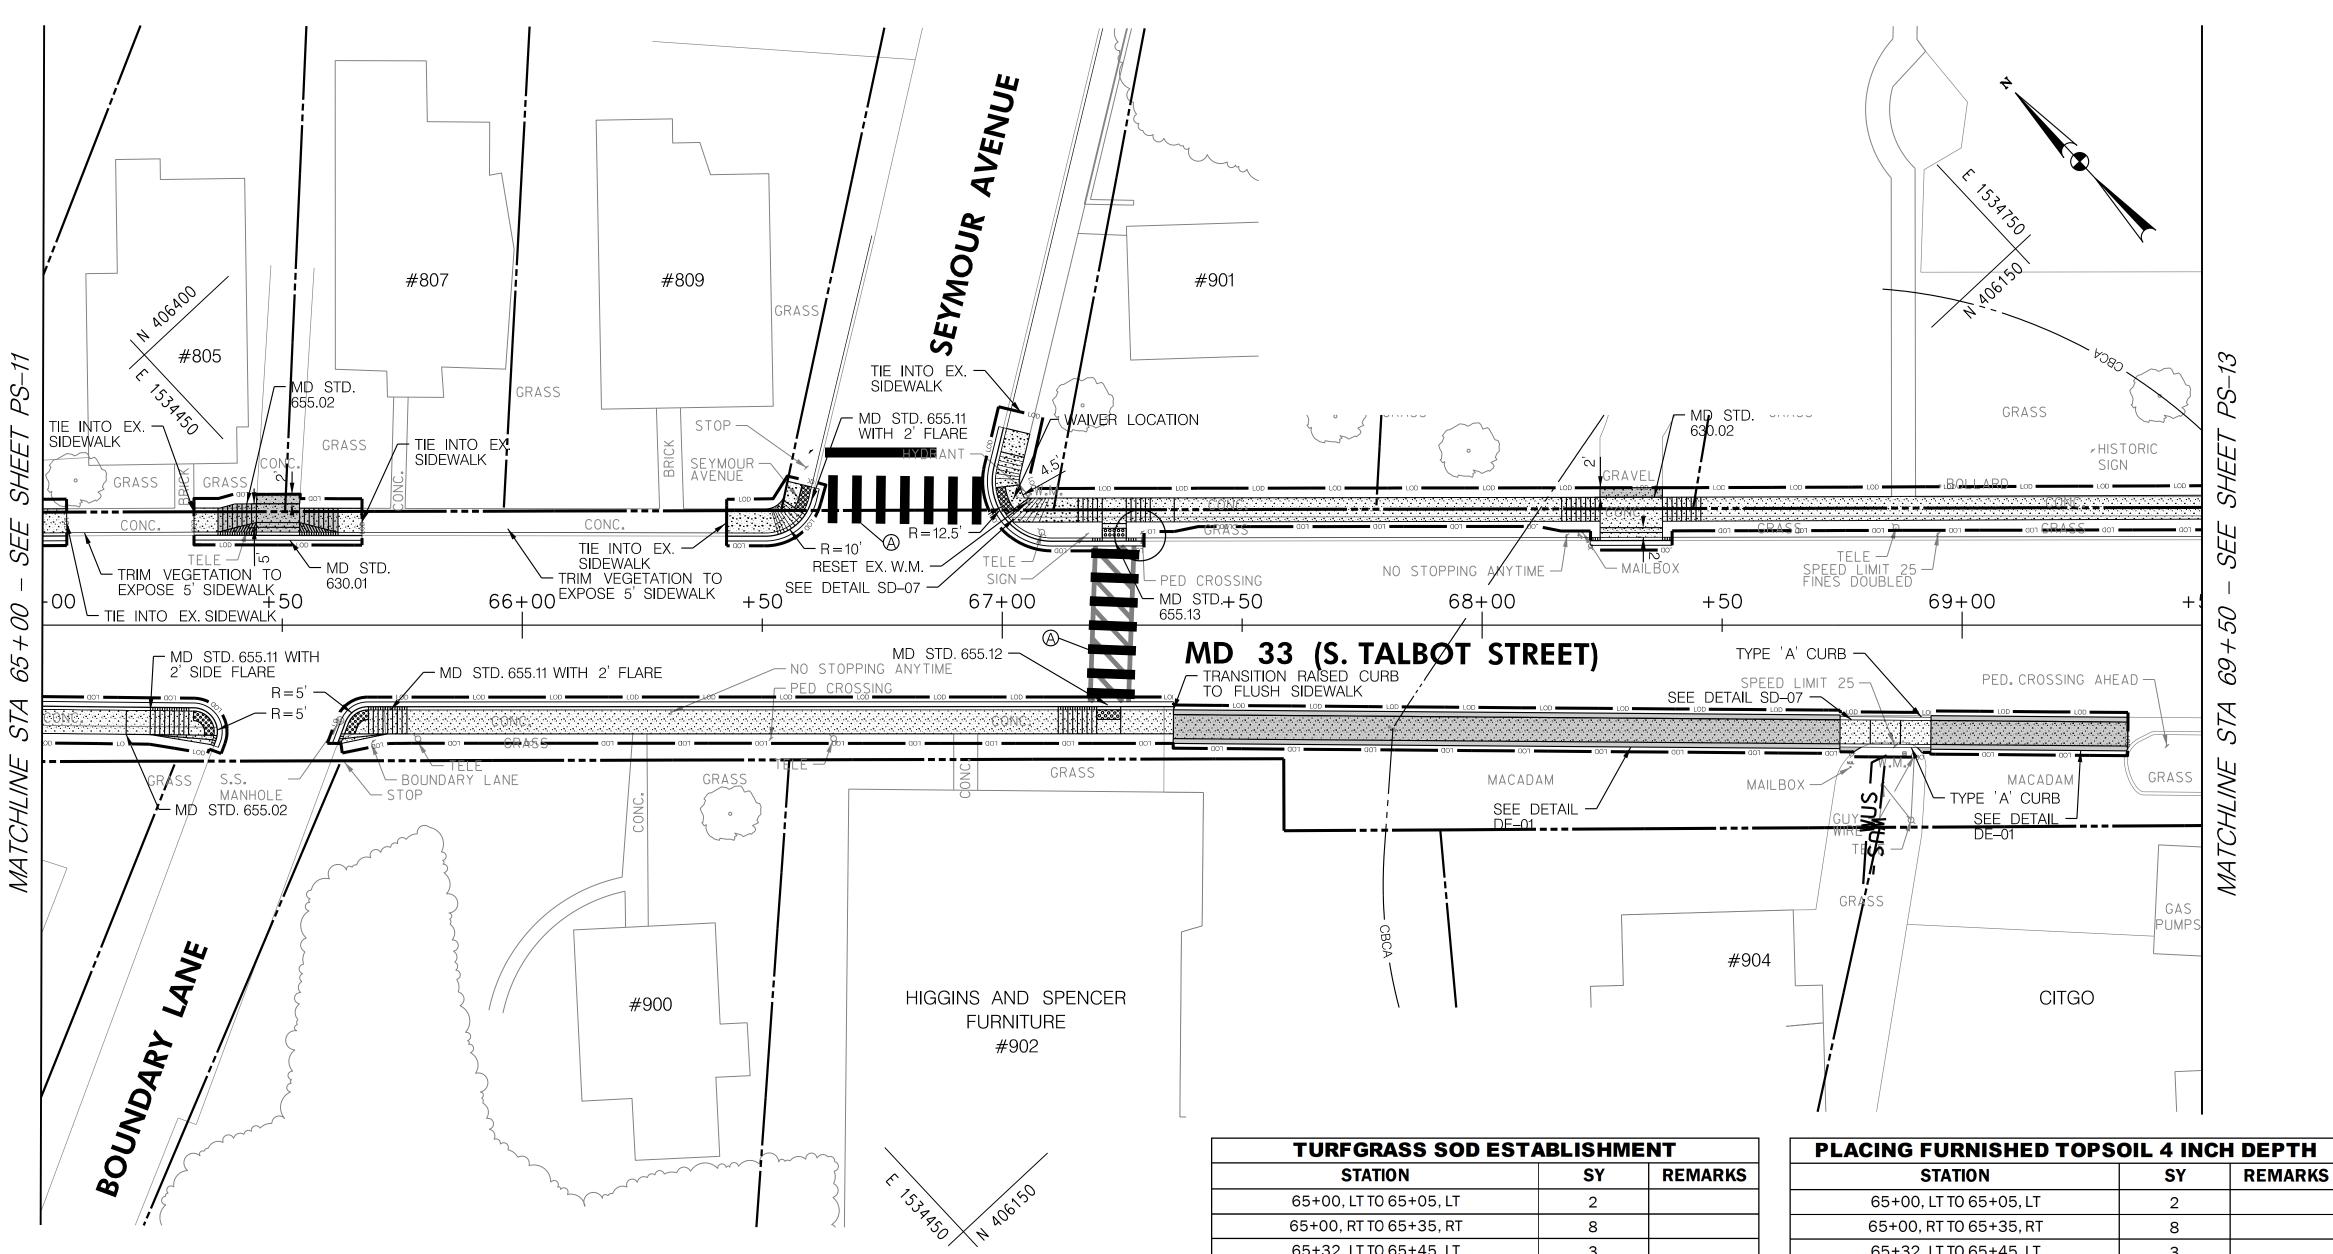

TURFGRASS SOD ESTABLISHMENT			
STATION	SY	REMARKS	
65+00, LT TO 65+05, LT	2		
65+00, RT TO 65+35, RT	8		
65+32, LT TO 65+45, LT	3		
65+54, LT TO 65+67, LT	3		
65+61, RT TO 66+23, RT	14		
66+26, RT TO 66+90, RT	15		
66+43, LT TO 66+60, LT	5		
66+95, RT TO 67+34, RT	9		
67+04, LT TO 67+21, LT	5		
67+07, LT TO 68+25, LT	31		
67+26, LT TO 68+25, LT	23		
68+38, LT TO 69+50, LT	26		
68+38, LT TO 68+85, LT	11		
68+90, LT TO 69+50, LT	14		

PLACING FURNISHED TOPSOIL 4 INCH DEPTH			
STATION	SY	REMARKS	
65+00, LT TO 65+05, LT	2		
65+00, RT TO 65+35, RT	8		
65+32, LT TO 65+45, LT	3		
65+54, LT TO 65+67, LT	3		
65+61, RT TO 66+23, RT	14		
66+26, RT TO 66+90, RT	15		
66+43, LT TO 66+60, LT	5		
66+95, RT TO 67+34, RT	9		
67+04, LT TO 67+21, LT	5		
67+07, LT TO 68+25, LT	31		
67+26, LT TO 68+25, LT	23		
68+38, LT TO 69+50, LT	26		
68+38, LT TO 68+85, LT	11		

68+90, LT TO 69+50, LT

MARYLAND DEPARTMENT

INNOVATIVE CONTRACTING DIVISION

REPACEMENT AND REPAIR OF SIDEWALKS IN DISTRICT 2 AREA WIDE

NOTE: SAME-DAY STABILIZATION SHALL BE PROVIDED FOR ALL

QUANTITY NOTES

8 INCH PORTLAND CEMENT CONCRETE **PAVEMENT FOR DRIVEWAY MIX 9**

TYPE A CURB ANY HEIGHT OR DEPTH

TYPE A COMBINATION CURB AND GUTTER

ANY HEIGHT OR DEPTH

5 INCH CONCRETE SIDEWALK

DETECTABLE WARNING SURFACE FOR CURB RAMPS

REMARKS

2 FT TIE-IN

2 FT TIE-IN

REMARKS

SEE DE-01

REMARKS

REMARKS

REMARKS

SY

18

78

3

23

19

19

43

35

179 21

53

17

25

180

25

25

845

65

1390

95

12

13

18

14

10

10

STATION

65+37, LT TO 65+62, LT

65+45 LT TO 65+54, LT

67+36, RT TO 68+75, RT

68+25, LT TO 68+38, LT

68+93, RT TO 69+35, RT

STATION

68+75, 25' RT TO 68+93, 26' RT

68+75, 20' RT TO 68+94, 20' RT

STATION

65+00, 19' LT TO 65+05, 19' LT

65+00, 17' RT TO 65+36, 25' RT

65+32, 19' LT TO 65+67, 19' LT 65+61, 25' RT TO 67+36, 17' RT

66+43, 18' LT TO 66+60, 26' LT

67+01, 45' LT TO 67+28, 18' LT

68+23, 18' LT TO 68+40, 18' LT

STATION

65+00, LT TO 65+05, LT

65+00, RT TO 65+36, RT

65+32, LT TO 65+37, LT

65+62, LT TO 65+67, LT

65+62, RT TO 67+36, RT

66+43, LT TO 66+60, LT

67+02, LT TO 69+50, LT

68+75, RT TO 68+94, RT

STATION 65+32, 20' RT

65+63, 23' RT

66+51, 19' LT

66+99, 27' LT

67+20, 18' RT

67+21, 20' LT

MD 33 (TALBOT STREET) 200' NORTH OF LEE STREET TO

150' SOUTH OF SPENCER DRIVE

DATE MARCH 2020 CONTRACT NO. ____TA2295133 COUNTY ___ TALBOT COUNTY PNK LOGMILE _ 12.852 TO 13.983 HORIZONTAL SCALE _____N/A

PS-12 OF PS-14

VERTICAL SCALE ____

3. SEE GENERAL NOTES ON SHEET DE-01 FOR ADDITIONAL CONSTRUCTION NOTES FOR CURB RAMPS, SIDEWALKS, AND MEDIANS.

1. ALL DISTURBED AREAS SHALL BE TEMPORARILY STABILIZED AT THE END OF EACH WORK DAY WITH TYPE 'E' SOIL


STABILIZATION MATTING IN PERVIOUS AREAS OR GRADED AGGREGATE BASE COURSE IN IMPERVIOUS AREAS.

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4. ALL TRANSITION SIDEWALK PANELS MUST BE CONSTRUCTED 5' MINIMUM OR TO THE NEXT EXISTING JOINT OR AS DIRECTED BY THE ENGINEER.

5. DRIVEWAY TIE-INS SHOULD MATCH EXISTING MATERIAL (ASPHALT/GRAVEL/BRICK)

NOTE TO CONTRACTOR:

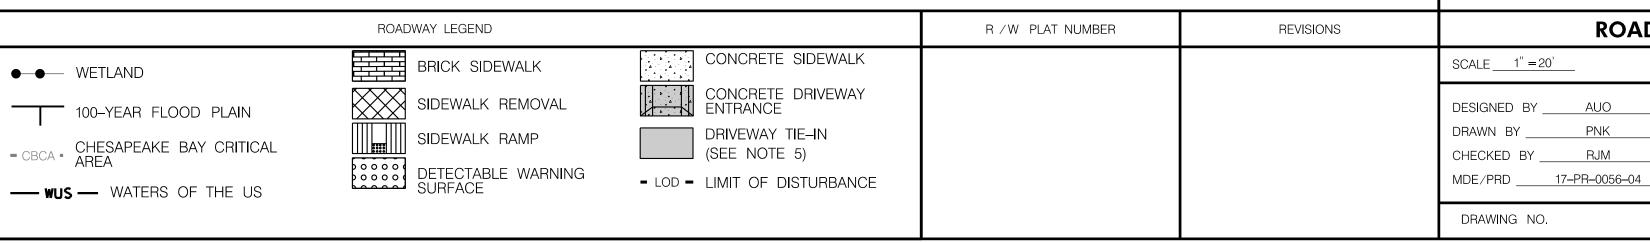

PAVEMENT MARKING LEGEND

(A) 24 INCH WHITE THERMOPLASTIC PAVEMENT MARKING (SOLID)

10 20 SCALE: I" = 20'

14

DATUM: NAD 83/91 Horizontal

NAVD 88 Vertical


OF TRANSPORTATION STATE HIGHWAY


ADMINISTRATION


DISTURBED AREAS.

SHEET NO. 23 OF 26

ROADWAY PLAN SHEET

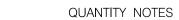

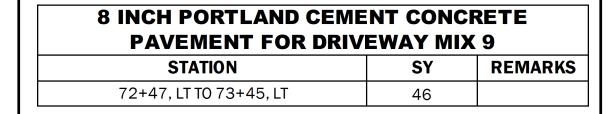

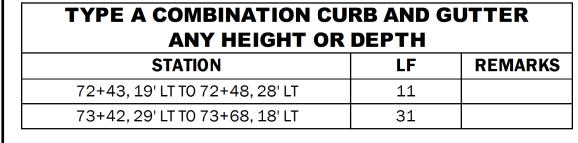

5 INCH CONCRETE SIDEWALK			
STATION	SF	REMARKS	
69+50, LT TO 72+48, LT	1535		
73+43, LT TO 74+00, LT	300		

PLACING FURNISHED TOPSOIL 4 INCH DEPTH			
STATION	SY	REMARKS	
69+50, LT TO 69+99, LT	11		
69+50, LT TO 69+99, LT	11		
70+07, LT TO 72+45, LT	54		
70+07, LT TO 71+69, LT	37		
71+75, LT TO 72+24, LT	11		
72+33, LT TO 72+42, LT	2		
73+42, LT TO 74+00, LT	13		

TURFGRASS SOD ESTABLISHMENT			
STATION	SY	REMARKS	
69+50, LT TO 69+99, LT	11		
69+50, LT TO 69+99, LT	11		
70+07, LT TO 72+45, LT	55		
70+07, LT TO 71+69, LT	37		
71+75, LT TO 72+24, LT	11		
72+33, LT TO 72+42, LT	2		
73+42, LT TO 74+00, LT	13		

NOTE: SAME-DAY STABILIZATION SHALL BE PROVIDED FOR ALL DISTURBED AREAS.

INNOVATIVE CONTRACTING DIVISION

REPACEMENT AND REPAIR OF

MARYLAND DEPARTMENT OF TRANSPORTATION

STATE HIGHWAY **ADMINISTRATION**

SCALE: I" = 20'

NAVD 88 Vertical

DATUM: NAD 83/91 Horizontal

SIDEWALKS IN DISTRICT 2 AREA WIDE MD 33 (TALBOT STREET) 200' NORTH

OF LEE STREET TO

N/A


150' SOUTH OF SPENCER DRIVE

ROADWAY PLAN SHEET

<u>)'</u>	DATE MARCH 2020	CONTRACT NO	TA2295133
AUO	COUNT	Y TALBOT	COUNTY
PNK	LOGMIL	E 12.852 7	ГО 13.983
RJM	—— HORIZC	NTAL SCALE	N/A


VERTICAL SCALE _


DRAWING NO. PS-13 OF PS-14 SHEET NO. 24 OF 26

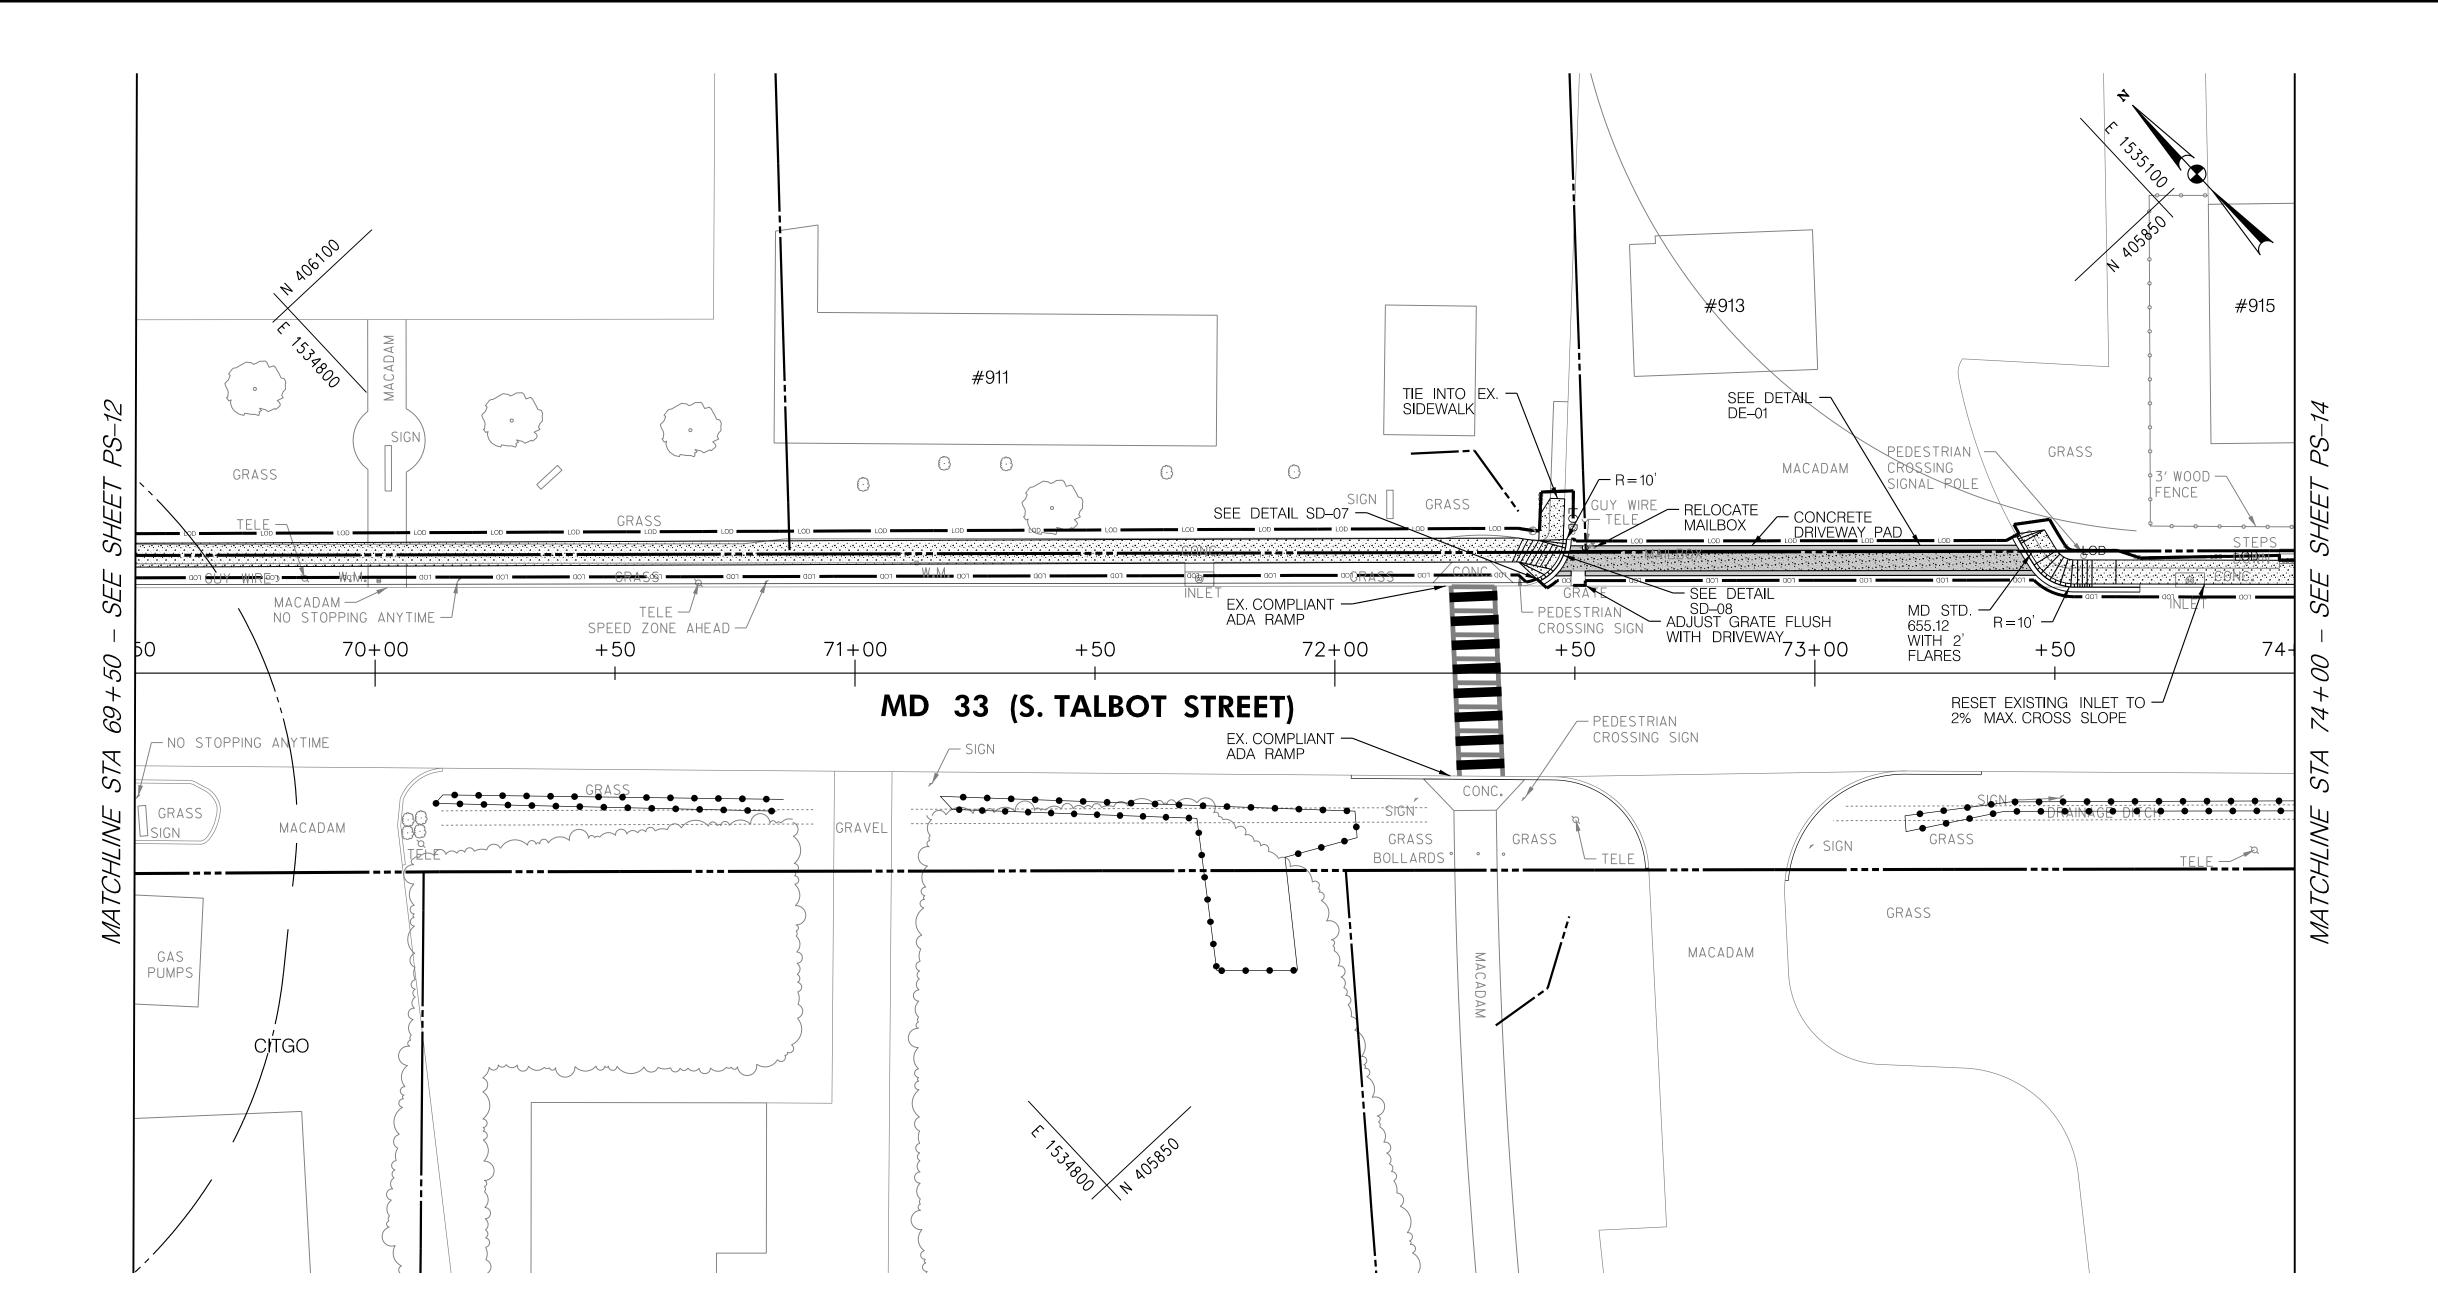

NOTE TO CONTRACTOR:

- 1. ALL DISTURBED AREAS SHALL BE TEMPORARILY STABILIZED AT THE END OF EACH WORK DAY WITH TYPE 'E' SOIL STABILIZATION MATTING IN PERVIOUS AREAS OR GRADED AGGREGATE BASE COURSE IN IMPERVIOUS AREAS.
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- 4. ALL TRANSITION SIDEWALK PANELS MUST BE CONSTRUCTED 5' MINIMUM OR TO THE NEXT EXISTING JOINT OR AS DIRECTED BY THE ENGINEER.
- 5. DRIVEWAY TIE-INS SHOULD MATCH EXISTING MATERIAL (ASPHALT/GRAVEL/BRICK)

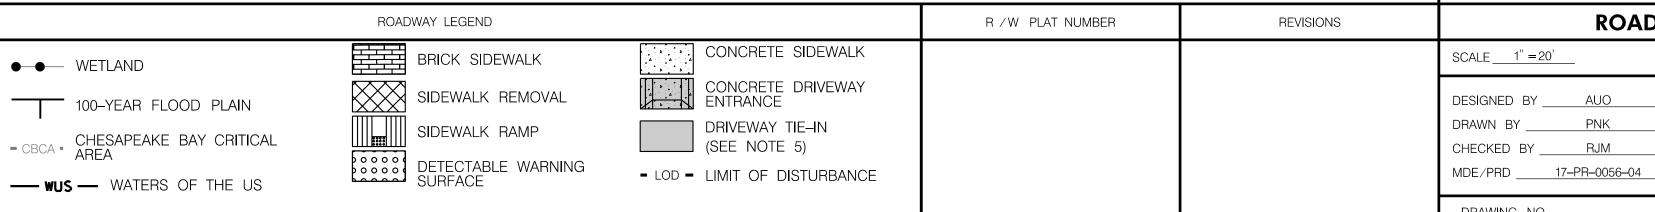

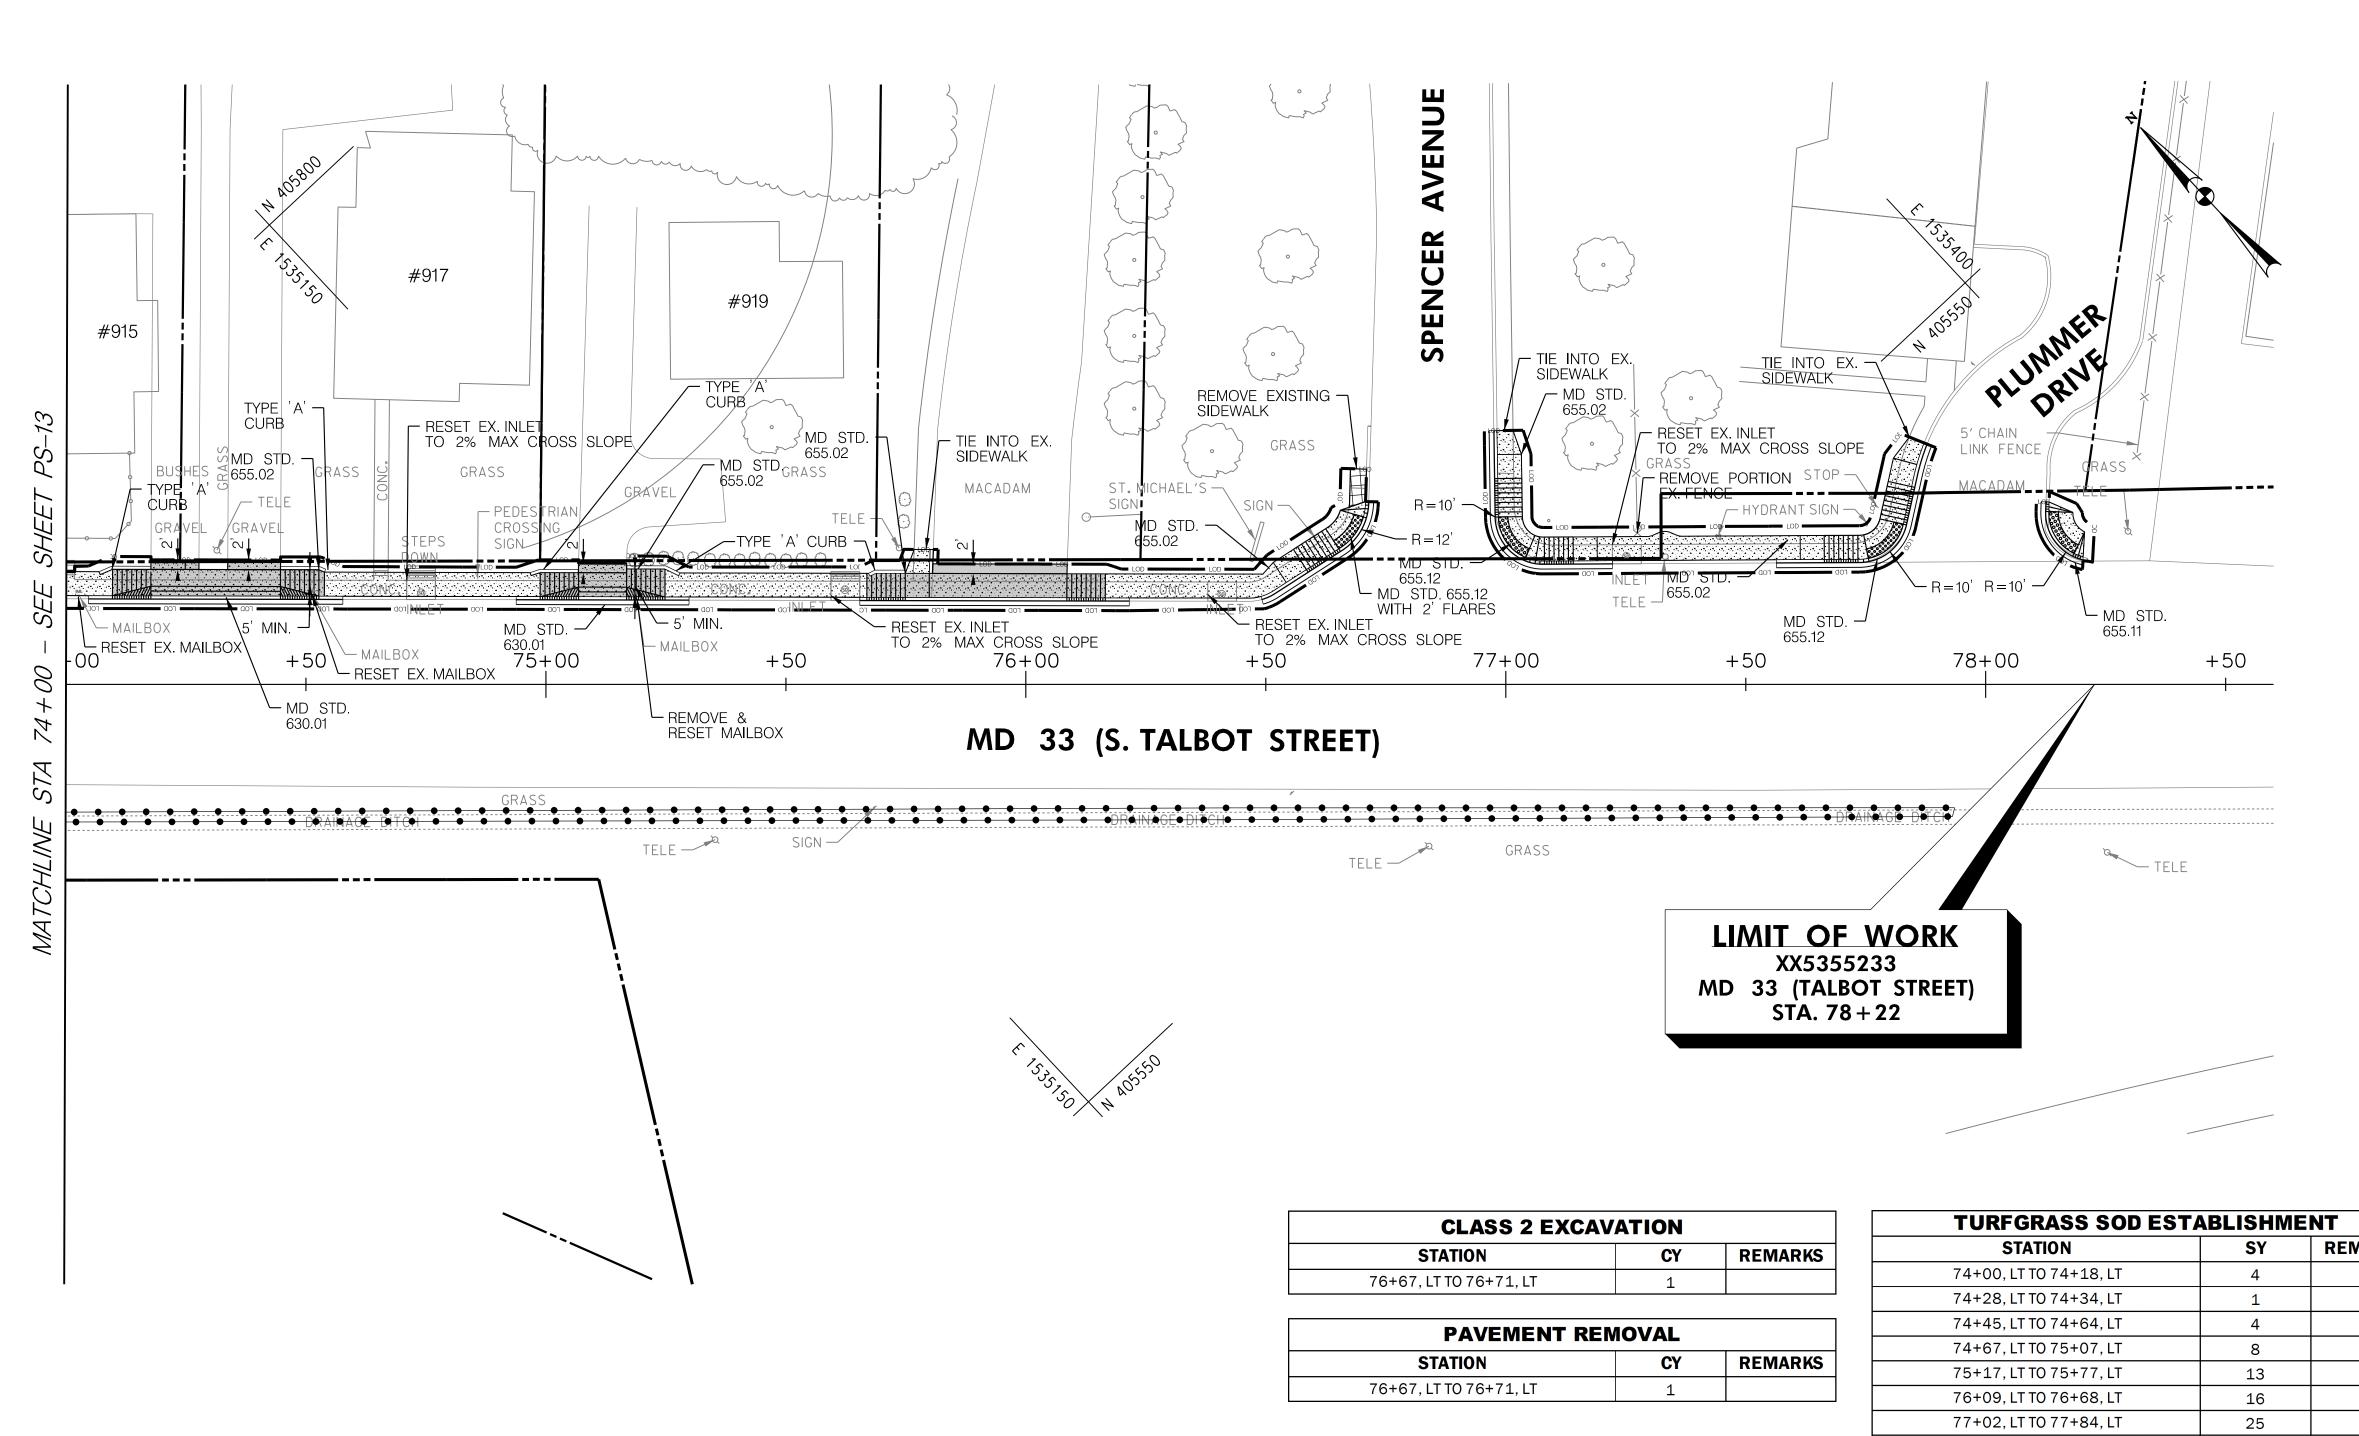

REMARKS 78+13, LT TO 78+22, LT 4

0 10 20

SCALE: I" = 20'

DATUM: NAD 83/91 Horizontal

QUANTITY NOTES

8 INCH PORTLAND CEMENT CONCRETE PAVEMENT FOR DRIVEWAY MIX 9				
STATION	SY	REMARKS		
74+10, LT TO 74+54, LT	32			
74+18, LT TO 74+28, LT	3			
74+34, LT TO 74+45, LT	3			
74+99, LT TO 75+25, LT	18			
75+07, LT TO 75+17, LT	3			
75+67, LT TO 76+17, LT	29			

	TYPE A CURB ANY HEIG	TYPE A CURB ANY HEIGHT OR DEPTH					
	STATION	LF	REMARKS				
	74+07, 23' LT TO 74+18, 25' LT	13	SEE DE-01				
	74+45, 25' LT TO 74+54, 24' LT	10	SEE DE-01				
	74+97, 23' LT TO 75+07, 24' LT	11	SEE DE-01				
	75+17, 25' LT TO 75+28, 23' LT	12	SEE DE-01				
	75+67, 23' LT TO 75+75, 24' LT	10	SEE DE-01				
Ī	75+80, 23' LT TO 75+80, 28' LT	5					

TYPE A COMBINATION CURB AND GUTTER ANY HEIGHT OR DEPTH				
STATION	LF	REMARKS		
74+05, 18' LT TO 74+58, 18' LT	53			
74+94, 18' LT TO 75+30, 18' LT	36			
75+65, 17' LT TO 76+22, 17' LT	56			
76+49, 18' LT TO 76+71, 38' LT	32			
76+98, 53' LT TO 77+22, 25' LT	48			
77+56, 25' LT TO 77+88, 50' LT	49			
78+13, 38' LT TO 78+20, 26' LT	16			

5 INCH CONCRETE SIDEWALK				
STATION	SF	REMARKS		
74+00, LT TO 74+10, LT	50			
74+54, LT TO 74+99, LT	225			
75+25, LT TO 75+67, LT	215			
75+75, LT TO 75+80, LT	25			
76+17, LT TO 76+71, LT	275			
76+98, LT TO 77+87, LT	570			
78+13, LT TO 78+20, LT	35			

DETECTABLE WARNING SURFACE FOR CURB RAMPS				
STATION	SF	REMARKS		
76+64, 30' LT	16			
76+98, 35' LT	20			
77+75, 28' LT	20			
78+13, 36' LT	20			

PLACING FURNISHED TOPSOIL 4 INCH DEPTH				
STATION	SY	REMARKS		
74+00, LT TO 74+18, LT	4			
74+28, LT TO 74+34, LT	1			
74+45, LT TO 74+64, LT	4			
74+67, LT TO 75+07, LT	8			
75+17, LT TO 75+77, LT	13			
76+09, LT TO 76+68, LT	16			
77+02, LT TO 77+84, LT	25			
78+13, LT TO 78+22, LT	4			

NOTE: SAME-DAY STABILIZATION SHALL BE PROVIDED FOR ALL DISTURBED AREAS.



INNOVATIVE CONTRACTING DIVISION

REPACEMENT AND REPAIR OF SIDEWALKS IN DISTRICT 2 AREA WIDE

MD 33 (TALBOT STREET) 200' NORTH OF LEE STREET TO

ADMINISTRATION 150' SOUTH OF SPENCER DRIVE

ROAD	'AWC	ΥP	LAN	SHEET	
SCALE 1" = 20'	DATE_	MARC	CH 2020	CONTRACT NO	TA2295133
DESIGNED BYAUO			COUNTY	TALBOT	COUNTY
DRAWN BYPNK			LOGMILE	12.852 T	O 13.983
CHECKED BY RJM			HORIZON	NTAL SCALE	N/A
MDE/PRD17-PR-0056-04			VERTICA	L SCALE	N/A
DRAWING NO.	PS-14	OF	PS-14	SHEET NO.	25 OF 26

NOTE TO CONTRACTOR:

- 1. ALL DISTURBED AREAS SHALL BE TEMPORARILY STABILIZED AT THE END OF EACH WORK DAY WITH TYPE 'E' SOIL STABILIZATION MATTING IN PERVIOUS AREAS OR GRADED AGGREGATE BASE COURSE IN IMPERVIOUS AREAS.
- 2. NO DISTURBED AREA SHALL BE LEFT UNSTABILIZED OVERNIGHT UNLESS THE RUNOFF IS DIRECTED TO AN MDE APPROVED SEDIMENT CONTROL DEVICE.
- 3. SEE GENERAL NOTES ON SHEET DE-01 FOR ADDITIONAL CONSTRUCTION NOTES FOR CURB RAMPS, SIDEWALKS, AND MEDIANS.
- 4. ALL TRANSITION SIDEWALK PANELS MUST BE CONSTRUCTED 5' MINIMUM OR TO THE NEXT EXISTING JOINT OR AS DIRECTED BY THE ENGINEER.
- 5. DRIVEWAY TIE-INS SHOULD MATCH EXISTING MATERIAL (ASPHALT/GRAVEL/BRICK)

				NAVD 88 Vertical	
	ROADWAY LEGEND		R /W PLAT NUMBER	REVISIONS	
• WETLAND	BRICK SIDEWALK	CONCRETE SIDEWALK			SCALE_
100-YEAR FLOOD PLAIN	SIDEWALK REMOVAL	CONCRETE DRIVEWAY ENTRANCE			DESIGNI
- CBCA - CHESAPEAKE BAY CRITICAL AREA	SIDEWALK RAMP	DRIVEWAY TIE-IN (SEE NOTE 5)			DRAWN CHECKE
	DETECTABLE WARNING SURFACE	- LOD - LIMIT OF DISTURBANCE			MDE/PF
					DRAWI

EROSION AND SEDIMENT CONTROL - GENERAL NOTES

1. NOTIFICATION

NOTIFY THE REGIONAL ENVIRONMENTAL COORDINATOR (REC) IN WRITING AND/OR BY TELEPHONE AT (410) 365-0164 PRIOR TO THE FOLLOWING POINTS:

- PRE-CONSTRUCTION MEETING.
- EROSION AND SEDIMENT CONTROL (ESC) MEETING (MINIMUM 7 WORKING DAYS PRIOR TO COMMENCING EARTH DISTURBING
- UPON INSTALLATION OF INITIAL ESC MEASURES.
- INSTALLATION OF MAJOR ESC BASINS/TRAPS.
- REMOVAL OR MODIFICATION OF ANY ESC MEASURES.
- REMOVAL OF ALL ESC DEVICES.
- FINAL ACCEPTANCE BY THE ADMINISTRATION.

2. STANDARDS AND SPECIFICATIONS

CONSTRUCT THIS PLAN ACCORDING TO THE MARYLAND DEPARTMENT OF THE ENVIRONMENT (MDE) "2011 MARYLAND STANDARDS AND SPECIFICATIONS FOR SOIL EROSION AND SEDIMENT CONTROL", THE MDE "2000 MARYLAND STORMWATER DESIGN MANUAL, VOLUMES I & II", THE MDOT SHA "FIELD GUIDE FOR EROSION AND SEDIMENT CONTROL", THE ANNOTATED CODE OF MARYLAND, THE CODE OF MARYLAND (COMAR) 26.17.01 AND 26.17.02, ALL REVISIONS THERE OF, AND AS SPECIFIED. KEEP A COPY OF THE 2011 "MARYLAND STANDARDS AND SPECIFICATIONS FOR SOIL EROSION AND SEDIMENT CONTROL" ON THE SITE AT ALL TIMES. PERFORM VEGETATIVE STABILIZATION ACCORDING TO THOSE STANDARDS AND AS SPECIFIED.

3. INSPECTION

DAILY INSPECT ALL ESC MEASURES AND MAINTAIN THEM IN A CONTINUOUSLY-EFFECTIVE OPERATING CONDITION UNTIL REMOVED AS APPROVED BY THE REC AND THE ENGINEER.

4. SHUTDOWNS / LIQUIDATED DAMAGES

COMPLETE COMPLIANCE WITH THE APPROVED ESC PLAN IS EXPECTED AT ALL TIMES. IN CASES WHERE THE CONTRACTOR IS FOUND TO BE IN NON-COMPLIANCE, THE ADMINISTRATION WILL TAKE STEPS TO IMPOSE SELECTED OR TOTAL SHUTDOWNS AND MAY IMPOSE LIQUIDATED DAMAGES FOR NON-COMPLIANCE.

THE ADMINISTRATION'S DISTRICT ENGINEER MAY IMPOSE A TOTAL OR PARTIAL SHUTDOWN IF THE PROJECT MAY ADVERSELY IMPACT THE WATERS OF THE STATE.

5. RECORD KEEPING

ENSURE THE STORMWATER MANAGEMENT (SWM)/ESC APPROVAL LETTER, APPROVED EROSION AND SEDIMENT CONTROL PLANS, APPROVED MODIFICATIONS, MODIFICATION APPROVAL LETTER(S), DAILY LOG BOOKS, TEST REPORTS, AND NATIONAL POLLUTANT DISCHARGE ELIMINATION SYSTEM (NPDES) NOTICE OF INTENT (NOI) PERMIT ARE AVAILABLE ON-SITE FOR REVIEW AND INSPECTION BY THE ADMINISTRATION.

6. CLEARING AND GRUBBING

UNLESS OTHERWISE SPECIFIED OR APPROVED, LIMIT THE CLEARING AND GRUBBING AREA TO A SINGLE 20-ACRE GRADING UNIT PER GRADING OPERATION. ONCE THIS FIRST UNIT IS HALF GRADED, STABILIZATION MEASURES ARE IN PLACE, AND APPROVED, WORK MAY PROCEED TO A SECOND 20-ACRE GRADING UNIT. UNLESS SPECIFICALLY APPROVED, NO MORE THAN 30 ACRES MAY BE DISTURBED AT ANY TIME.

7. SENSITIVE AREAS

WITH THE APPROVAL AND ASSISTANCE OF THE ENGINEER, COORDINATE WITH THE APPROPRIATE ADMINISTRATION REPRESENTATIVES TO COORDINATE WITH THE APPROPRIATE REGULATORY AGENCIES TO ENSURE THAT ALL PERMIT CONDITIONS ARE MET PRIOR TO COMMENCING CONSTRUCTION ACTIVITIES WITHIN SPECIFIED SENSITIVE AREAS. SENSITIVE AREAS INCLUDE BUT ARE NOT LIMITED TO FLOODPLAINS, WETLANDS, WETLAND BUFFERS, CHESAPEAKE BAY CRITICAL AREA, FORESTS, ARCHEOLOGICAL SITES, HISTORIC SITES, PARKLAND, AND OPEN WATERS. DESIGNATE A RESPONSIBLE PARTY TO MONITOR ALL WORK IN THESE AREAS AND ENSURE THAT REASONABLE CARE IS TAKEN DURING WORK IN AND ADJACENT TO THESE AREAS.

8. INGRESS / EGRESS CONTROLS

PROTECT ALL POINTS OF CONSTRUCTION INGRESS AND EGRESS AND PREVENT THE DEPOSITION OF MATERIALS ON PUBLIC ROADS. IF DEPOSITION OCCURS, MECHANICALLY REMOVE ALL MATERIALS DEPOSITED ON PUBLIC ROADS IMMEDIATELY. FLUSHING OF ROAD SURFACES IS PROHIBITED.

9. EROSION AND SEDIMENT CONTROL EXCAVATION

DISPOSE OF MATERIAL REMOVED FROM ESC DEVICES IN AN APPROVED WASTE SITE AS SPECIFIED IN SECTION 201. MATERIALS MAY BE STORED FOR RE-USE. MATERIALS STORED ON-SITE MAY BE REUSED ONCE IT IS DRIED AND IF IT MEETS THE REQUIREMENTS FOR EMBANKMENTS OR OTHER UNSPECIFIED NEEDS.

10. DEWATERING PRACTICES

OPERATE DEWATERING PRACTICES IN A MANNER THAT DOES NOT DISCHARGE SEDIMENT INTO WATERWAYS. NO VISIBLE CHANGES TO STREAM CLARITY ARE ACCEPTABLE.

11. STANDARD STABILIZATION NOTE

FOLLOWING INITIAL SOIL DISTURBANCE OR REDISTURBANCE, COMPLETE PERMANENT OR TEMPORARY STABILIZATION WITHIN THREE (3) CALENDAR DAYS FOR SURFACES OF ALL PERIMETER CONTROLS, DIKES, SWALES, DITCHES, PERIMETER SLOPES, AND ALL SLOPES GREATER THAN 3 HORIZONTAL TO 1 VERTICAL (3:1); AND SEVEN (7) DAYS AS TO ALL OTHER DISTURBED OR GRADED AREAS ON THE SITE. ENSURE CONTINUED STABILIZATION.

12. INCREMENTAL STABILIZATION

REFER TO THE MDE "2011 MARYLAND STANDARDS AND SPECIFICATIONS FOR SOIL EROSION AND SEDIMENT CONTROL" FOR THE INCREMENTAL STABILIZATION OF CUT AND FILLS.

13. SEDIMENT TRAPS AND BASINS

PLAN DIMENSIONS ARE RELATIVE TO THE OUTLET ELEVATION.
MAINTAIN INFLOW AND OUTFLOW LOCATIONS FOR TRAPS AND BASINS
IN STABLE CONDITION.

14. OFF-SITE UTILITY WORK

FOLLOW ADDITIONAL BEST MANAGEMENT ESC PRACTICES FOR UTILITY CONSTRUCTION IN AREAS OUTSIDE OF DESIGNED CONTROLS:

(a) CALL "MISS UTILITY" AT 1-800-257-7777 AT LEAST 48 HOURS

PRIOR TO THE START OF WORK.

(b) PLACE EXCAVATED MATERIAL ON THE HIGH SIDE OF TRENCHES.

(c) BACKFILL, COMPACT, AND STABILIZE AT THE END OF EACH

WORKING DAY ALL TRENCHES FOR UTILITY
INSTALLATIONS. WHEN THIS IS NOT POSSIBLE, CONFORM TO (d).
(d) PLACE TEMPORARY SILT FENCES IMMEDIATELY DOWNSTREAM
OF ANY DISTURBED AREA THAT IS INTENDED TO REMAIN
DISTURBED FOR MORE THAN ONE (1) DAY.

15. SITE INFORMATION*

A. TOTAL AREA DISTURBED	1.12	ACRES
B. TOTAL CUT	13	_ CU. YD
C. TOTAL FILL	0	_ _ CU. YD
D. OFFSITE WASTE/BORROW AREA		
LOCATION (IF KNOWN)	TBD BY CONTRACTOR	_

* (NOT FOR BIDDING PURPOSES)

16. MODIFICATIONS

SUBMIT MODIFICATIONS OF THE ESC MEASURES OR PLAN TO THE ADMINISTRATION FOR APPROVAL. OBTAIN ALL APPROVALS PRIOR TO IMPLEMENTING ANY MODIFICATION.

STANDARD SYMBOLS						
AT-GRADE INLET PROTECTION	AGIP	PERMANENT SOIL STABILIZATION MATTING-TYPE B	BBBB	TEMPORARY ACCESS BRIDGE	ТВ	
BAFFLE BOARDS		PERMANENT SOIL STABILIZATION MATTING-TYPE C		TEMPORARY ACCESS CULVERT		
BENCHING	BENCHING	PIPE OUTLET SEDIMENT TRAP ST I	ST-I	TEMPORARY ASPHALT BERM	T <u>AB</u>	
CATCH BASIN INSERT	СПСВІ	PIPE SLOPE DRAIN NOTE: DESIGNATION PSD-12 REFERS TO PIPE SLOPE DRAIN WITH 12 IN PIPE	PSD - 12	TEMPORARY BARRIER DIVERSION	TBD	
CLEAR WATER DIVERSION PIPE NOTE: DESIGNATION CWD-12 REFERS TO CLEAR WATER DIVERSION WITH 12 INCH PIPE.	CWD - 12	PLUNGE POOL	PP	TEMPORARY GABION OUTLET STRUCTURE	TGOS	
CLEAR WATER PIPE	⊢∏⊢ CWP	PORTABLE SEDIMENT TANK	⊠PST	TEMPORARY SOIL STABILIZATION MATTING-TYPE A		
COMBINATION INLET PROTECTION	[]coiP	REMOVABLE PUMPING STATION	⊠RPS	TEMPORARY SOIL STABILIZATION MATTING-TYPE E		
CONCRETE WASHOUT STRUCTURE	CWS	RIPRAP INFLOW PROTECTION	RRP	TEMPORARY SOIL STABILIZATION MATTING-TYPE D		
CURB INLET PROTECTION	[4] CIP	RIPRAP OUTLET SEDIMENT TRAP ST III	ST-III	TEMPORARY STONE OUTLET STRUCTURE	◆ SSS TSOS	
DIVERSION FENCE	├── DF ───I	ROCK OUTLET PROTECTION I	ROPI	TEMPORARY SWALE NOTE: PLACE DESIGNATION (A-1, B-2, ETC.) ON FLOW CHANNEL SIDE OF SWALE.	← A-I	
EARTH DIKE NOTE: PLACE DESIGNATION (A-1, B-2, ETC.) ON FLOW CHANNEL SIDE OF DIKE.	<u> </u>	ROCK OUTLET PROTECTION II	ROPII	VERTICAL DRAW-DOWN DEVICE	VDDD	
EMERGENCY SPILLWAY	ES	ROCK OUTLET PROTECTION III	ROPIII	WASH RACK OPTION	[WR]	
FILTER BAG	⊠FB	SILT FENCE	⊢ ——SF——₁	CHESAPEAKE BAY CRITICAL AREA	—— СВСА ——	
FILTER BERM	iFB-Ai iFB-Bi	SILT FENCE ON PAVEMENT	⊢—SF0P——I	DRAINAGE BOUNDARY	DA	
FILTER LOG NOTE: DESIGNATION FL-18 REFERS TO FILTER LOG WITH 18 INCH DIAMETER.	FL-18	SOD	* * * * * * * * * * * * * * * * * * * *	EXISTING CONTOURS	<u> </u>	
GABION INFLOW PROTECTION	ਊ GP □	STABILIZED CONSTRUCTION ENTRANCE (SCE)	SCE SCE	LIMIT OF DISTURBANCE (LOD)	—— LOD ——	
GABION INLET PROTECTION	[]GIP	STANDARD INLET PROTECTION	[] SIP	PROPOSED CONTOURS	—— 100 ——	
HORIZONTAL DRAW-DOWN DEVICE	HDDD	STOCKPILE AREA		TEMPORARY ORANGE CONSTRUCTION FENCE (TOCF)		
LIMIT OF DISTURBANCE	——LOD——	STONE CHECK DAM	CD	TREE PROTECTION FENCE	TPF	
MEDIAN INLET PROTECTION	MIP	STONE/RIPRAP OUTLET SEDIMENT TRAP ST II	ST-II	WETLAND	• • • • •	
MEDIAN SUMP INLET PROTECTION	MSIP	SUBSURFACE DRAINS	├─ SSD ── ┤	WETLAND BUFFER	— в —	
MOUNTABLE BERM	MB	SUMP PIT	⊠sp	100-YEAR FLOODPLAIN		
PERIMETER DIKE/SWALE	₽DS-I	SUPER SILT FENCE	⊢—SSF——I			
		<u>I</u>		1		

SEQUENCE OF CONSTRUCTION

- 1. NOTIFY THE REGIONAL ENVIRONMENTAL COORDINATOR (REC) AT LEAST SEVEN (7) WORKING DAYS AT (410)365-0164 TO ARRANGE FOR A PRE-CONSTRUCTION MEETING PRIOR TO BEGINNING CONSTRUCTION. WORK MAY NOT COMMENCE UNTIL THE PERMITTEE OR THE RESPONSIBLE PERSONNEL HAVE MET ON SITE WITH THE SEDIMENT AND EROSION CONTROL INSPECTOR TO REVIEW THE APPROVED PLANS.
- 2. WHERE NO STABILIZED CONSTRUCTION ENTRANCE (SCE) IS PROVIDED, DESIGNATE PIECES OF CONSTRUCTION EQUIPMENT THAT SHALL BE ALLOWED WITHIN THE LIMIT OF DISTURBANCE (LOD). KEEP THIS EQUIPMENT WITHIN THE LOD UNTIL THE PROPOSED WORK IS COMPLETE. CLEAN TREADS AND TIRES PRIOR TO LEAVING THE LOD. LIFT ALL MATERIAL REMOVAL AND LOAD OUT FROM THE LOD.
- 3. CONSTRUCT SIDEWALK/ RAMP IMPROVEMENTS. (60 DAYS)
- 4. DO NOT LEAVE ANY DISTURBED AREA UNSTABILIZED OVERNIGHT.



INNOVATIVE CONTRACTING DIVISION

MD 33 (TALBOT STREET) 200' NORTH

REPACEMENT AND REPAIR OF

OF LEE STREET TO

150' SOUTH OF SPENCER DRIVE

REVISIONS	EROSION AND S	EDIMENT CONTROL GENERAL NOTES	
	SCALE NTS	DATE MARCH 2020 CONTRACT NO. TA2295133	
	DESIGNED BYAUO	COUNTY TALBOT COUNTY	_
	DRAWN BY PNK	LOGMILE 12.852 TO 13.983	_
	CHECKED BYRJM	HORIZONTAL SCALE N/A	_
	MDE/PRD17-PR-0056-04	VERTICAL SCALEN/A	_
	DRAWING NO.	ES-01 OF ES-01 SHEET NO. 26 OF 26	